


# 16610-16618 W VENTURA BLVD, LOS ANGELES CA 91436

		IDDIU-IDDIO VV VEINIURA DLVD, LUS AI	1
PROJECT ADDRESS	INDEX ARCHITECTURAL	PROJECT DATA           NEW MIXED-USE, COMMERCIAL RESIDENTIAL BUILDING. FIRST FLOOR COMMERCIAL AND	PARKING CALCULATION PARKING REQUIRED PER LAMC 12.22.A25 OPTION1
16610-16618 W VENTURA BLVD, LOS ANGELES, CA 91436	SHEET TITLE T.O COVER SHEET	PROPOSED: PARKING, 4-RESIDENTIAL STORIES (45) UNITS, 5 STORIES IN TOTAL OVER 2- LEVEL BASEMENT PARKING	# OF AUTO UNITS PARKING TOTAL
PROJECT OWNER	T1.1DIAGRAMS, B&C CODE ANALYSIST1.2DIAGRAMS, B&C CODE ANALYSIST1.3DIAGRAMS, B&C CODE ANALYSIST1.4FLOOR AREA RATIO	LEGAL DESCRIPTION PORTION OF LOT 4, ARB 1&2, BLOCK 11 TRACT NO. 2955, IN THE CITY OF LOS ANGELES, COUNTY OF LOS ANGELES, STATE OF CALIFORNIA AS PER MAP RECORDED IN M.B. 31, PAGE 62-70 OF MAPS, IN THE OFFICE OF THE COUNTY RECORDER OF SAID COUNTY.	STUDIO         4         1         4           1-         BDRM         17         1         17           2-         DDDM         24         1.5         76
BENELISHA GROUP INC	T1.5 OPEN SPACE DIAGRAM A1.0 SITE PLAN	APN: 2284-007-001 (ARB1) , 2284-007-026(ARB2)	2- BDRM         24         1.5         36           TOTAL         45         57
15451 MORRISON ST SHERMAN OAKS CA 91403	A2.0 BASEMENT PLAN A2.1 FIRST FLOOR PLAN	ZONE: C4-1L	PROVIDED FOR RESIDENTIAL
PHONE: (818) 787.8911	A2.2SECOND FLOOR PLANA2.3THIRD FLOOR PLANA2.4FOURTH FLOOR PLAN	AREA AND BUILDING CALCULATIONS	PARKING No. STANDARD 49
DESIGN BY	A2.5     FIFTH FLOOR PLAN       A2.6     SIXTH FLOOR PLAN       A2.7     ROOF PLAN	TYPE OF CONSTRUCTION:2- BASEMENT LEVELANDFIRST FLOOR TYPE I-A GARAGE FULLY SPRINKLERED (NFPA-13). SECOND FLOOR TO FIFTH FLOOR TYPEV-A FULLY SPRINKLERED THROUGHOUT (NFPA-13).	STANDARD49COMPACT13DISABLE PARKING1
G.A. ENGINEERING LIC# C61464 6747 ODESSA AVE. SUITE 204	A3.0 ELEVATIONS A3.1 ELEVATIONS	OCCUPANCY GROUP R-2 / S-2 PARKING	TOTAL AUTO PARKING RESIDENTS63SHORT-TERM BICYCLE PARKING REQUIRED= 5 SPACES , PROVID
VAN NUYS, CA. 91406 PHONE: (818)758-0018	A3.2COLOREDELEVATIONSA3.3COLOREDELEVATIONSA3.4COLOREDELEVATIONS(FROM ADJACENT)A4.0SECTIONS	LOT AREA: 10,365.6 SQ.FT + 10,388.8 SQ.FT = 20,754.4 (PER ZIMAS). STORIES: 5 STORIES	LONG TERM BICYCLE REQUIRED= 45 SPACES, PROVIDED 45
STRUCTURAL ENGINEER	A5.0 DOORS & WINDOWS SCHEDULE	- STORIES: 5 STORIES INTERIOR SIDE YARDS: 0'-0" AT FIRST FLOOR, 8 FEET FROM 2ND- 5TH FLOOR	" NO GUEST PARKING" 2% of number of parking= 2%x63 =1.26=2 accessible park
G.A. ENGINEERING LIC# C61464		BUILDING SETBACKS REQUIRED : FRONT YARD : MINIMUM 18" FEET, MAXIMUM 10 FEET	EV PARKING= 30% X 63 =19 EV PARKING PROVIDED EV PARKING
6747 ODESSA AVE. SUITE 204 VAN NUYS, CA. 91406 PHONE: (818)758-0018		REAR YARD : 20 FEET	10%X19 =1.9 =2 EVCS PARKING (INSTALL CHARGER REQUIRED)
		BUILDING SETBACKS PROVIDED : FRONT YARD + 18" FEET	17 EVCAPABLE COMMERCIAL AUTO PARKING REQUIRED
SURVEY A.J.A		BUILDING SETBACKS PROVIDED : FRONT YARD : 18" FEET REAR YARD : 20 FEET	FLOOR AREA USE RATE TOTAL
7411 FLORENCE AVE, DOWNEY CA 90240		ALLOWABLE BUILDING HEIGHT: 45 FEET	3,400 SQ,FT, COMMERCIAL 3,400/250 . 12 STANDA (RETAIL) SQ.FT. 2 COMAPCT
PHONE: (562)760-6040		62 FEET MAXIMUM HEIGHT	TOTAL PROVIDED 14
GEOTECHNICAL ENGINEER		PROPOSED BUILDING HEIGHT: OFF MENU INCENTIVE OF 11 FEET HEIGHT INCREASE PER LAMC 12.22.A25 + 6 FEET STAIRCASE PROJECTION	SHORT-TERM BICYCLE PARKING REQUIRED=1 PER 2,000 (MINIMUM PROVIDED SHORT TERM = 2 SPACES
A.G.I GEOTECHNICAL INC		PER SPECIFIC PLAN WITH TOTAL HEIGHT PROVIDED 62 FEET	LONG-TERM BICYCLE PARKING REQUIRED=1 PER 2,000 (MINIMUM PROVIDED LONG TERM = 2 SPACES
16555 SHERMAN WAY , SUIT A VAN NUYS, CA. 91406 PHONE: (818)758–0018		AREA SUMMARY (LABC)	OPEN SPACE CALCULATION
LANDSCAPING		STORY OCC. USE A A B C D A-B-C A-B-C-D AREA: AREA: AREA: VENTILATION AREA: STAIRWAYS AREA AREA AREA: AREA	REQUIRED NO. OF HABITABLE QUANTITY
SARMEN INC	L-1FIRST FLOORPLANTING PLANL-2FOURTH FLOORPLANTING PLAN	BASEMENT-2 <sup>S-2</sup> PARKING I-A 15,150 EXTERIOR WALLS SHAFT SQ.FT. SQ.FT. SQ.FT. (SQ.FT.)	BEDROOMSROOMSOF UNITSOPEN SPACESTUDIO244 X 100 = 400
10847 WESCOTT AVE SUNLAND , CA. 91040 PHONE: (818)482-3737	L-3FIFTH FLOORPLANTING PLANL-4PLANTING NOTES AND DETAILS	BASEMENT-2     S-2     PARKING     I-A     15,150	1   2   17   17X   100 = 1,700
FROME. (818)482-3737	L-5IRRIGATION NOTES AND LEGENDSL-6FIRST FLOOR IRRIGATION PLANL-7FOURTH FLOOR IRRIGATION PLAN	FIRST S-2 PARKING I-A 9,500 R-2 COMMERCIAL(retail) I-A 3,400 C 2 COMMERCIAL(retail) I-A 3,400 C 2 COMMERCIAL(retail) I-A 3,400 C 2 COMMERCIAL(retail) I-A 3,400 C 2 C 2 C 2 C 2 C 2 C 2 C 2 C 2 C 2 C 2	2         3         24         24X 125 = 3,000           TOTAL REQUIRED         5,100 SQ.FT
ELECTRICAL ENGINEER	L-8 FIFTH FLOOR IRRIGATION PLAN L-9 IRRIGATION DETAILS	R-2         LOBBY         III-A         1,450         ~         ~         1,450         1,450	
	L-10IRRIGATION DETAILSL-11IRRIGATION SPECIFICATIONSL-12PLANTING SPECIFICATIONS	SECOND         R-2         RESIDENTIAL         III-A         13,400         400         100         760         12,900         12,140           THIRD         R-2         RESIDENTIAL         III-A         13,400         400         100         760         12,900         12,140	PROVIDED
	L-13 PLANTING SPECIFICATIONS	THIRD         R-2         RESIDENTIAL         III-A         13,400         400         100         760         12,900         12,140           FOURTH         R-2         RESIDENTIAL         III-A         11,600         400         100         760         12,900         12,140	AREA DESCRIPTION OPEN SPACE
		FIFTH         R-2         RESIDENTIAL         III-A         7,600         250         100         760         7,250         6,490	DECK © 5TH FLOOR 4,000 SQ.FT. DECK © 4TH FLOOR 990 SQ.FT.
MECHANICAL & PLUMBING ENGINEE	R <u>s-0</u> s-0A	TOTAL S-2 39,800	BALCONY28X501,400SQ.FT.TOTALPROVIDED6,390SQ.FT.
	S-1 S-2 S-3	ALLOWABLE R-2 49,000 45,960	
	S-4           S-5           S-6	SCHOOL DISTRICT ASSESSABLE ALLOWABLE FLOOR AREA CALCULATION (LAMC)	DENSITY CALCULATION
	S-7 S-8	LOT AREA: 20,754.4 SQ.FT. (PER SURVEY)	
	S-9 SD-1 TO	STORY USE AREA (SQ.FT.) ZONE: C4-1 VL	BUILDABLE AREA:
	SD-10 SH-0 SH-1	FIRST       DWELLING UNITS       3,400+1,100       BUILDABLE AREA SHALL HAVE THE SAME MEANING         SECOND       DWELLING UNITS       13,400       AS LOT AREA AT C4 ZONE	C4-1VL ZONE
	SH-2 SH-3	THIRD     DWELLING UNITS     13,400       AS LOT AREA AT C4 ZONE       BUILDABLE AREA: 20,754.4 SQ.FT.	
	SH-4 SH-5	FOURTH     DWELLING UNITS     11,600       FIFTH     DWELLING UNITS     7,600   FAR: 1.5:1 FOR MIXED USE	209.71'
	CIVIL	TOTAL 50,500 ALLOWABLE FLOOR AREA PER SPECIFIC PLAN:	LOT AREA: 20,754.4 SQ.FT. (PER SURVEY)
	C0COVER SHEETC-1.0BASEMENT-2GRADING PLANC-1.1BASEMENT-1GRADING PLAN	20,754 SQ.FT. X 1.5 =31,131 SQ.FT	BUILDABLE AREA SHALL HAVE THE SAME MEANING AS LOT AREA AT C
	C12 FIRST FLOOR GRADING PLAN C-1.3 SECTIONS	OFF MENU INCENTIVE (REQUEST FOR F.A.R) FAR: 2.3 :1	DENSITY =1 UNIT/400 SQ.FT
		20,754.4 SQ.FT. X2.3=47,735.1 SQ.FT > 45,960 SQ.FT (PROVIDED)	ALLOWABLE BASE UNITS=20,754.4/400 =51.88 = 52 UNIT
		AREA PER UNIT	MAXIMUM ALLOWABLE DENSITY BONUS IS = 1.35%X52= 71 UNIT
			PROPOSED UNITS= 45 UNIT TO QUALIFY FOR 3 ADDITIONAL INCENTIVES =
		$\begin{array}{ c c c c c c c c c c c c c c c c c c c$	52(BASE DENSITY) X 15% = $7.8$ = 8 UNITS ALLOCATED TO
		201       2       BED/1 - BATH       501       2       BED/1 - BATH       601       2       BED/1 - BATH       500         202       1 - BED/1 - BATH       550       302       1 - BED/1 - BATH       550       402       1 - BED/1 - BATH       550         503       2 - BED/2 - BATH       830	VERY LOW INCOME TENANTS         52 X 15% = 8 UNITS ALLOCATED TO VERY LOW INCOME TENANTS
		203       2-BED/2-BATH       830       303       2-BED/2-BATH       830       403       2-BED/2-BATH       830         204       2-BED/2-BATH       1,000       304       2-BED/2-BATH       1,000       404       2-BED/2-BATH       1,000         205       2       BED/2-BATH       1,000       404       2-BED/2-BATH       1,000       505       2-BED/2-BATH       900	REQUESTED ENTITLEMENTS:
		205       2-BED/2-BATH       1,100       305       2-BED/2-BATH       1,100       405       2-BED/2-BATH       1,100       506       2-BED/2-BATH       1,100         206       2-BED/2-BATH       1,100       306       2-BED/2-BATH       1,100       406       2-BED/2-BATH       1,100       506       2-BED/2-BATH       1,100         207       2-BED/2-BATH       970       307       2-BED/2-BATH       970       407       STUDIO/1BATH       485       FIFTH FLOOR = 7 UNITS	1) OFF MENU INCENTIVE OF 11 FEET HEIGHT INCREASE PER LAMC 12.2 AFFORDABLE HOUSING + 6 EXTRA HEIGHT FOR STAIR CASE PROJEC
		208       STUDIO/1-BATH       500       308       STUDIO/1-BATH       500       408       1-BED/1-BATH       650         209       1-BED/1-BATH       810       309       1-BED/1-BATH       810       409       STUDIO/1BATH       500	PER SPECIFIC PLAN TOTAL 17 FEET HEIGHT INCREASE 2) OFF MENU INCENTIVE FOR FLOOR AREA INCREASE FROM 1.5:1 TO 2
		210         1-BED/1-BATH         750         310         1-BED/1-BATH         750         410         1-BED/1-BATH         750           211         1-BED/1-BATH         750         311         1-BED/1-BATH         750         411         1-BED/1-BATH         1,150	PER LAMC 12.22.A25, AFFORDABLE HOUSING
		212       2-BED/2-BATH       1,150       312       2-BED/2-BATH       1,150       412       1-BED/1-BATH       850         213       1-BED/1-BATH       850       313       1-BED/1-BATH       850       412       1-BED/1-BATH       850         2ND       FLOOR       = 13       UNITS       3RD       FLOOR       PLAN       = 13       UNITS       4TH       FLOOR       PLAN       = 12       UNITS	3) OFF-MENU INCENTIVE, IN THE REGIONAL COMMERCIAL PLAN DES AREA, BUILDINGS ABUTTING A MAJOR OR SECONDARY HIGHWAY EXCEED 45 FEET IN HEIGHT, IF, FOR EACH 10 FOOT INCREMENT 45 FEET, AT LEAST A TEN FOOT SETBACK FROM THE ROOF PER
			IS PROVIDED. 4) WAIVER OF TRANSITION HEIGHT AS REQUIRED BY LAMC 12.21.1A.10
L	1		1

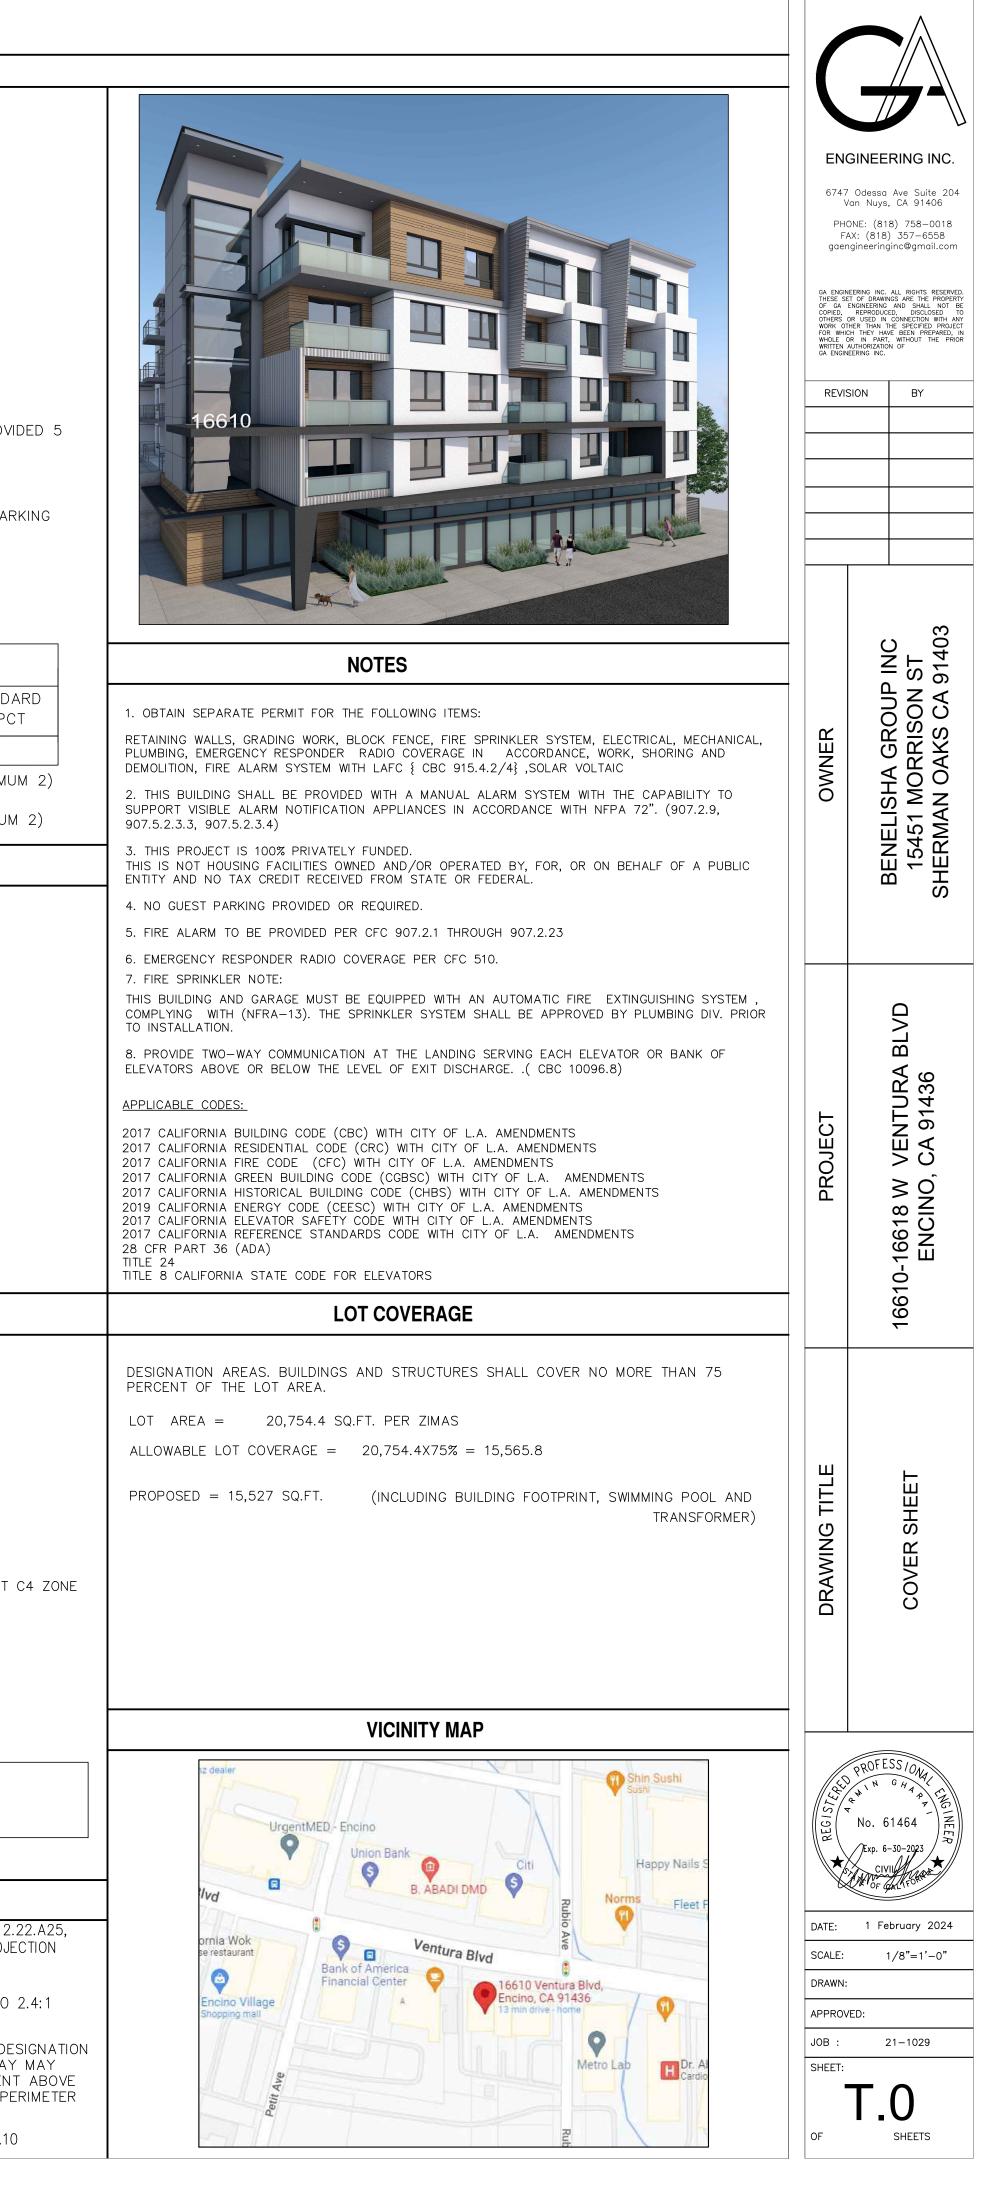


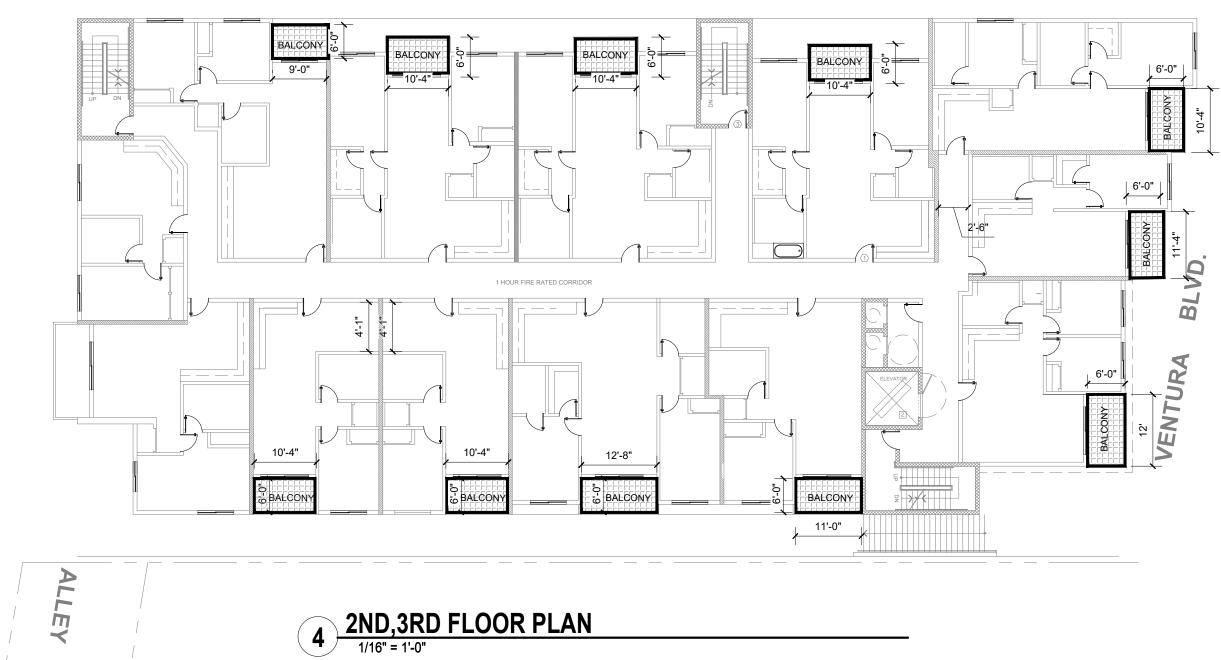

OPEN SPACE= 11 X50 =550 SQ.FT 550 X2 =1,100 SQ.FT

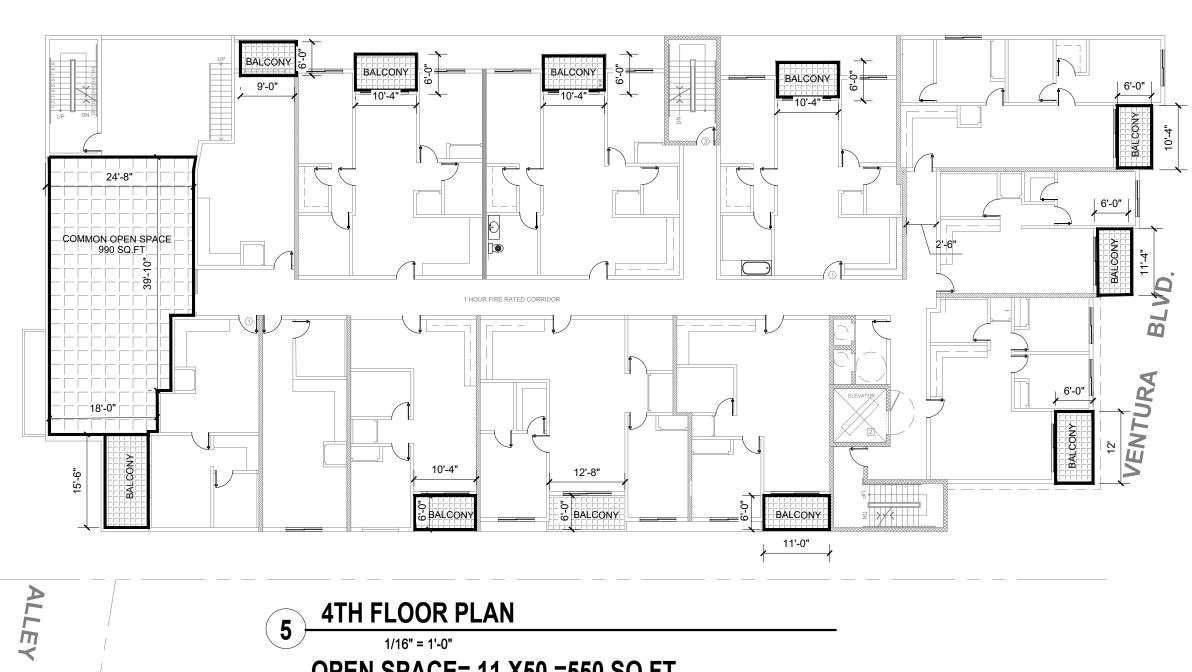

OPEN SPACE= 11 X50 =550 SQ.FT

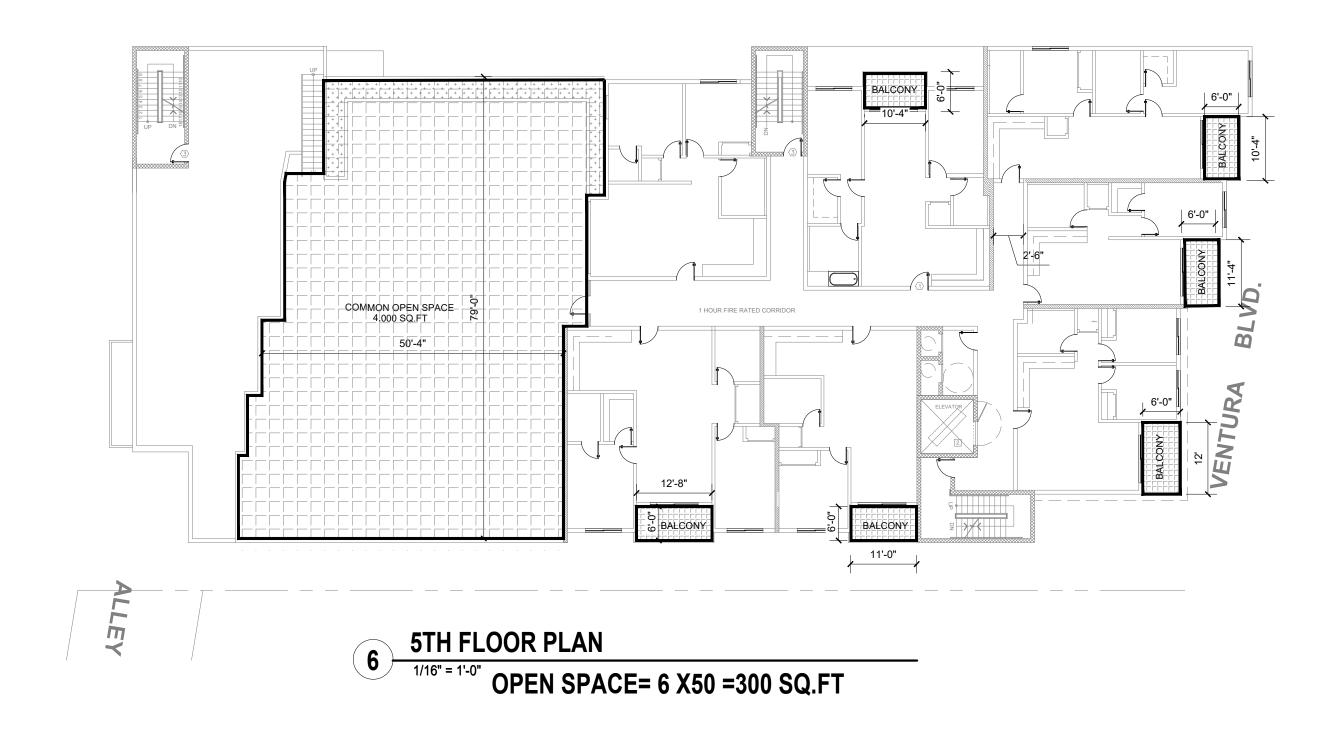


### REQUIRED


NO. OF BEDROOMS	HABITABLE ROOMS	QUANTITY OF UNITS	OPEN SPACE
STUDIO	2	4	4 X 100 = 400
1	2	17	$17X \ 100 = 1,700$
2	3	24	24X 125 = 3,000
TOTAL REQUIRED			5,100 SQ.FT

### PROVIDED

AREA DESCRIPTION	OPEN SPACE
DECK @ 5TH FLOOR	4,000 SQ.FT.
DECK @ 4TH FLOOR	990 SQ.FT.
BALCONY 28X50	1,400 SQ.FT.
TOTAL PROVIDED	6,390 SQ.FT.


Odessa an Nuys, DNE: (81 X: (818) gineering	RING INC. Ave Suite 204 CA 91406 8) 758–0018 357–6558 inc@gmail.com ALL RIGHTS RESERVED. IGS ARE THE PROPERTY AND SHALL NOT BE ED. DISCISSED TO CONNECTION WITH ANY HE SPECIFIC PROPERTY AND SHALL NOT BE ED. DISCISSED TO CONNECTION WITH ANY HE SPECIFIC PROPERTY NOF
BENELISHA GROUP INC	15451 MORRISON ST SHERMAN OAKS CA 91403
	16610 VEN I UKA BLVD ENCINO, CA 91436
	OPEN SPACE DIAGRAM
Exp. 6-	-30-2023
	ebruary 2024 /16"=1'-0"
ED:	
2	21—1029
۲ſ	I.5 SHEETS

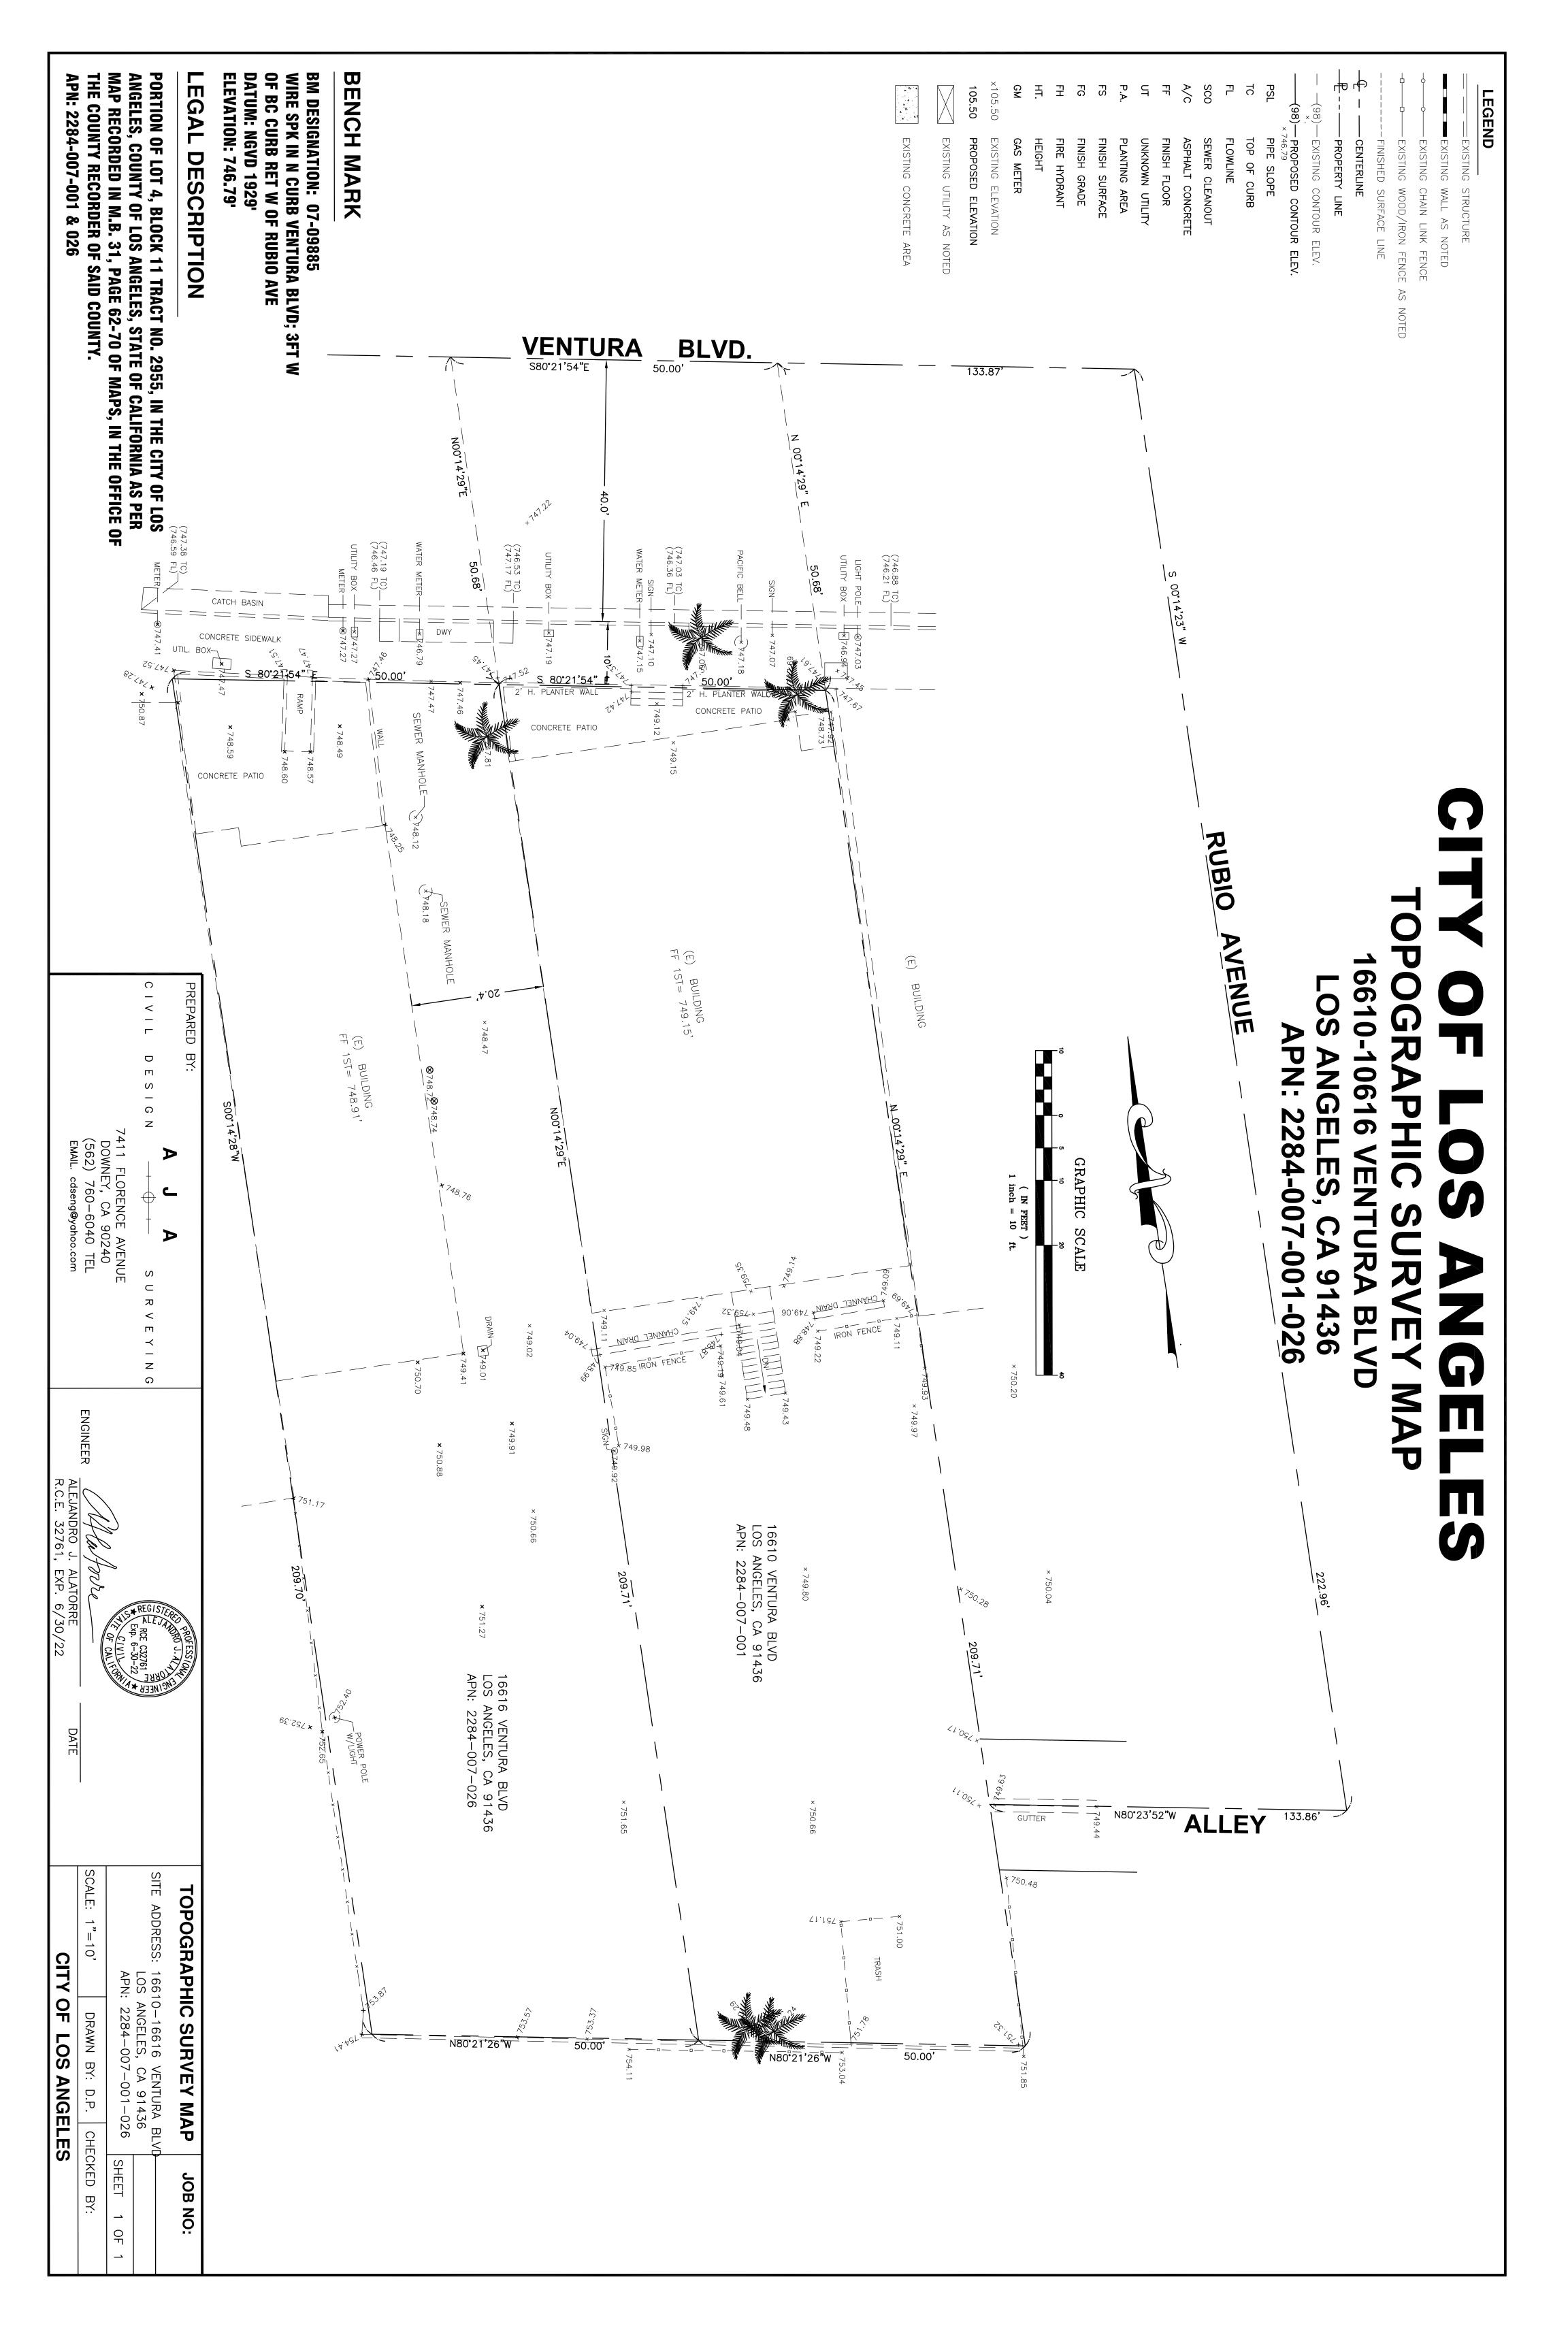


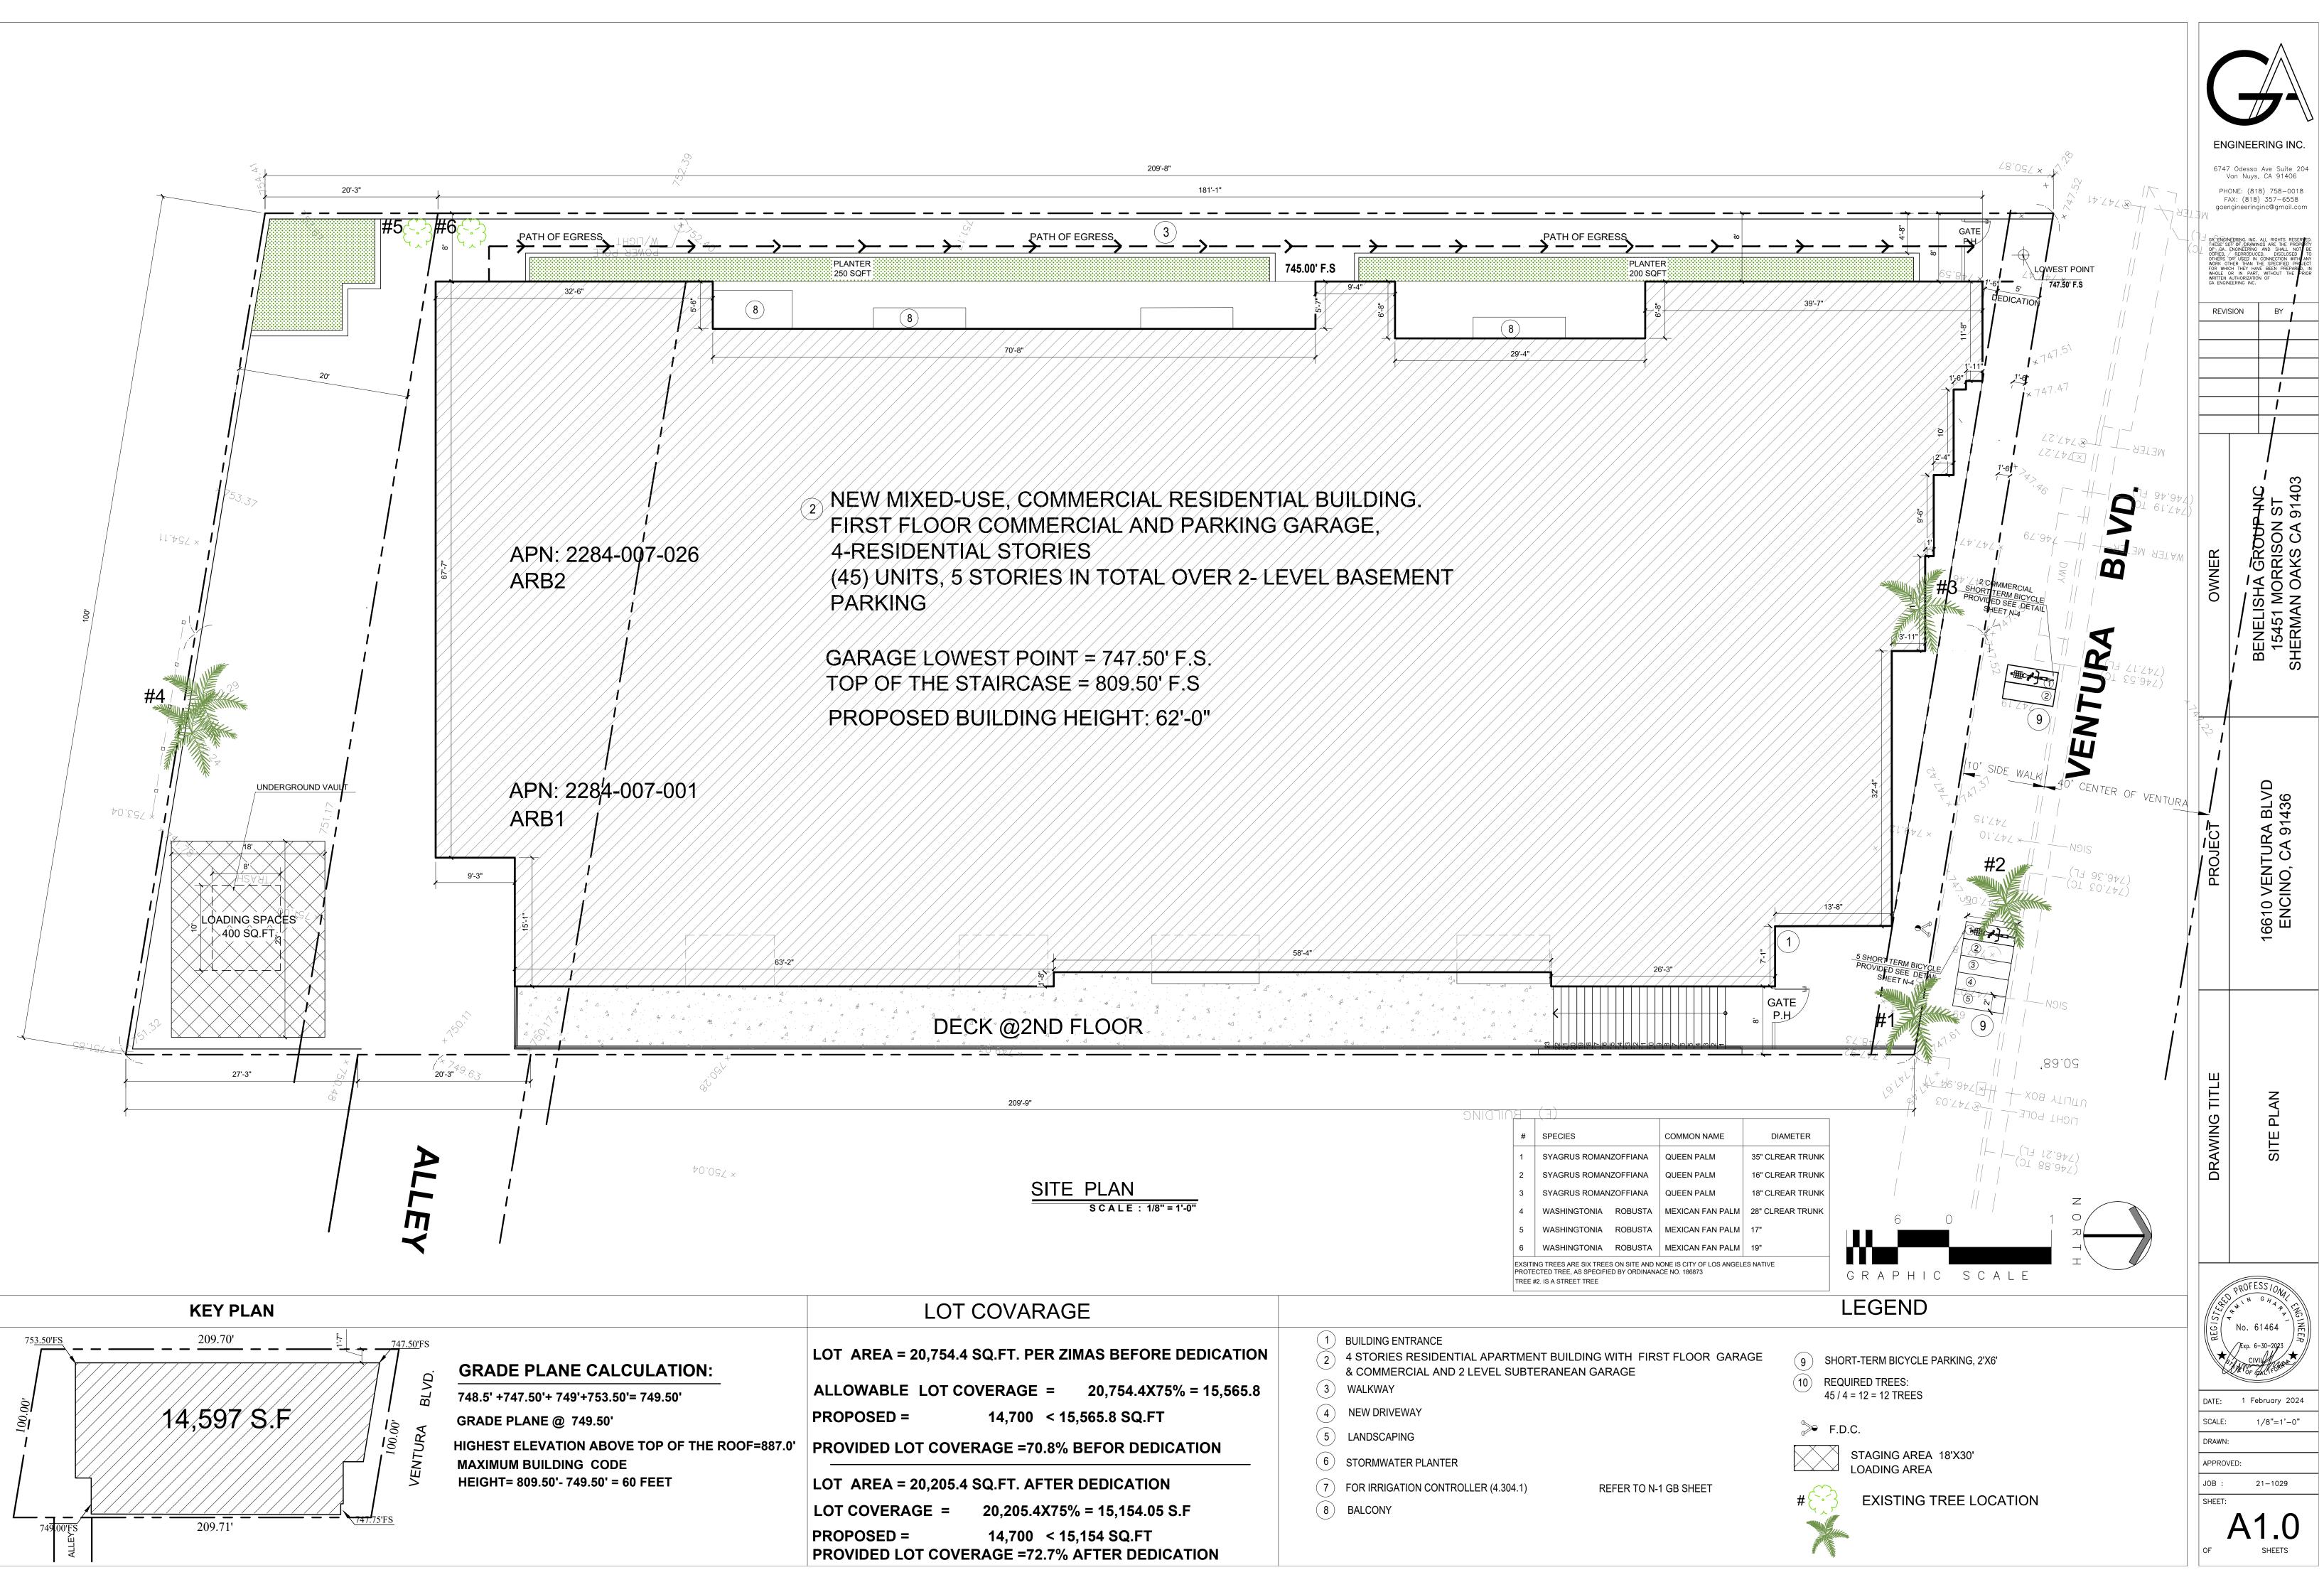



			209'-8"		
			181'-1"		
	PLANTER 250 SQFT	<u> </u>		745.00' F.S	PL 20
	8			20	
7   + 		70'-8"			(8)

209'-9"	
SITE PLAN scale: 1/8" = 1'-0"	9 NIGTINE       (1)         #       SPECIES         1       SYAGRUS ROMANZOFFIAN         2       SYAGRUS ROMANZOFFIAN         3       SYAGRUS ROMANZOFFIAN         4       WASHINGTONIA         5       WASHINGTONIA         6       WASHINGTONIA         8       Exsiting TREES ARE SIX TREES ON SITE         9       PROTECTED TREE, AS SPECIFIED BY ORD         10       TREE #2. IS A STREET TREE
LOT COVARAGE	
LOT AREA = 20,754.4 SQ.FT. PER ZIMAS BEFORE DEDICATION ALLOWABLE LOT COVERAGE = 20,754.4X75% = 15,565.8 PROPOSED = 14,700 < 15,565.8 SQ.FT .0' PROVIDED LOT COVERAGE =70.8% BEFOR DEDICATION LOT AREA = 20,205.4 SQ.FT. AFTER DEDICATION LOT COVERAGE = 20,205.4X75% = 15,154.05 S.F PROPOSED = 14,700 < 15,154 SQ.FT	<ol> <li>BUILDING ENTRANCE</li> <li>4 STORIES RESIDENTIAL APARTMENT BUILDING WITH F &amp; COMMERCIAL AND 2 LEVEL SUBTERANEAN GARAGE</li> <li>WALKWAY</li> <li>NEW DRIVEWAY</li> <li>LANDSCAPING</li> <li>STORMWATER PLANTER</li> <li>FOR IRRIGATION CONTROLLER (4.304.1)</li> <li>REFER TO</li> <li>BALCONY</li> </ol>

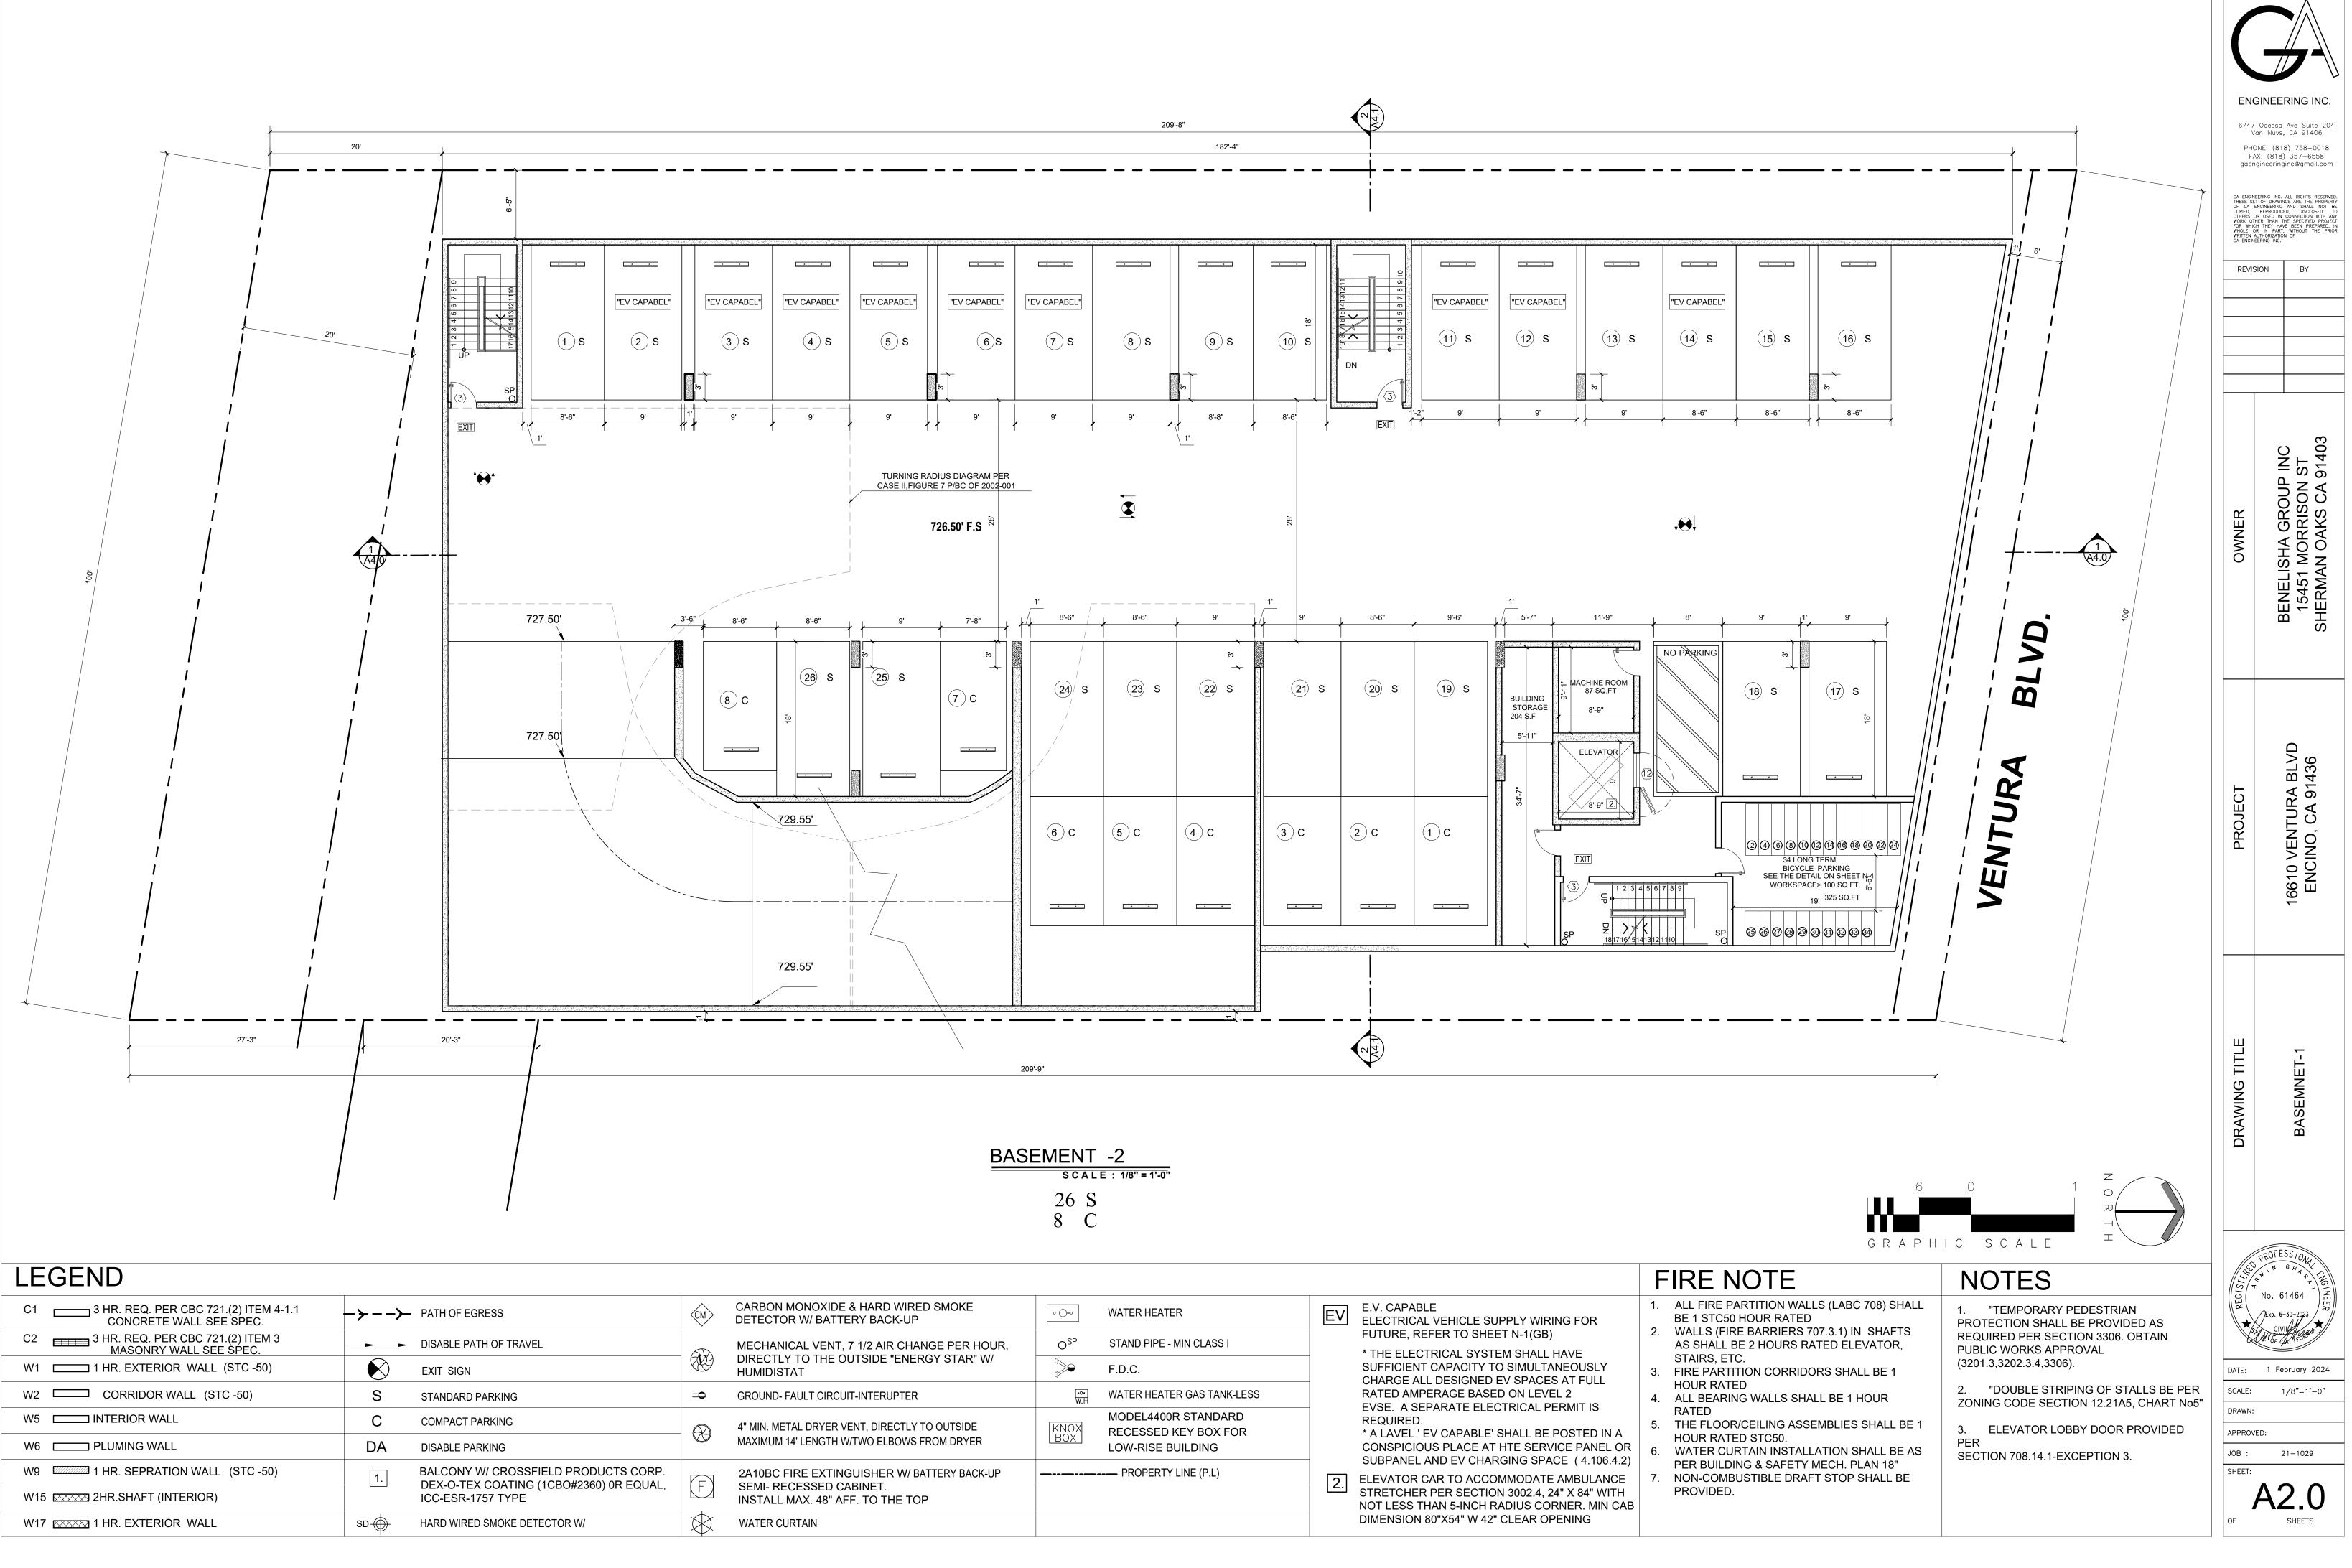

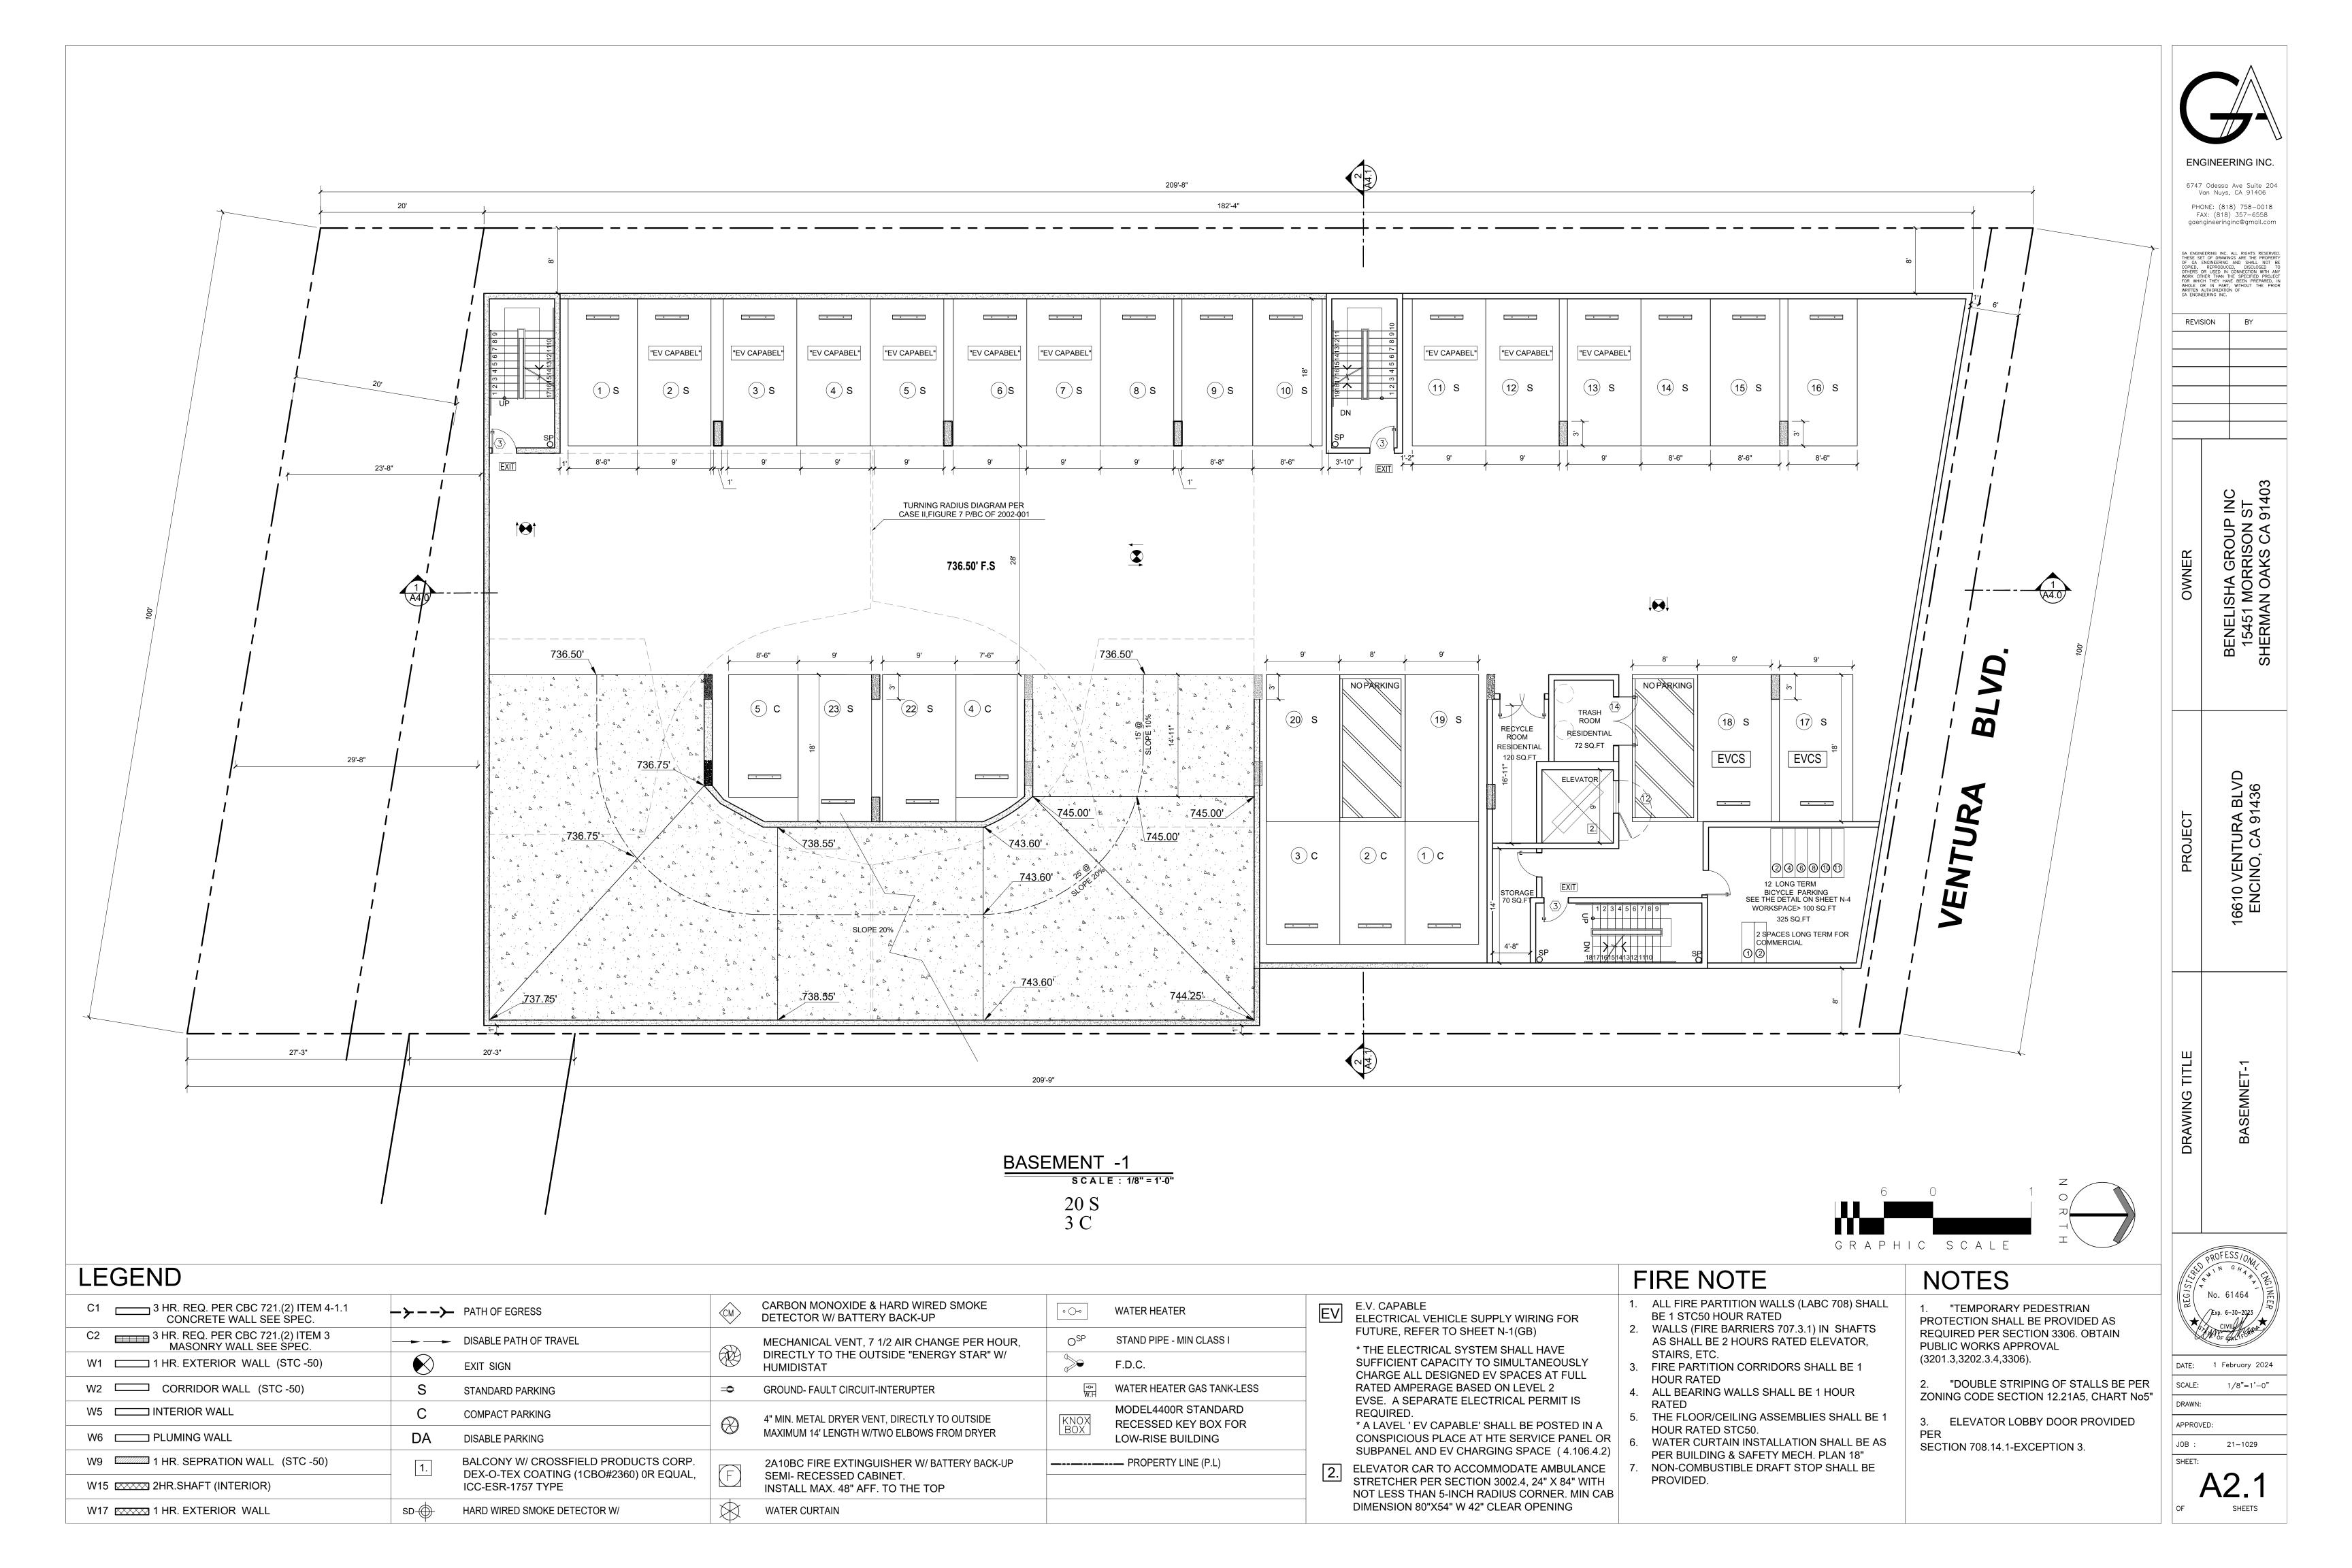

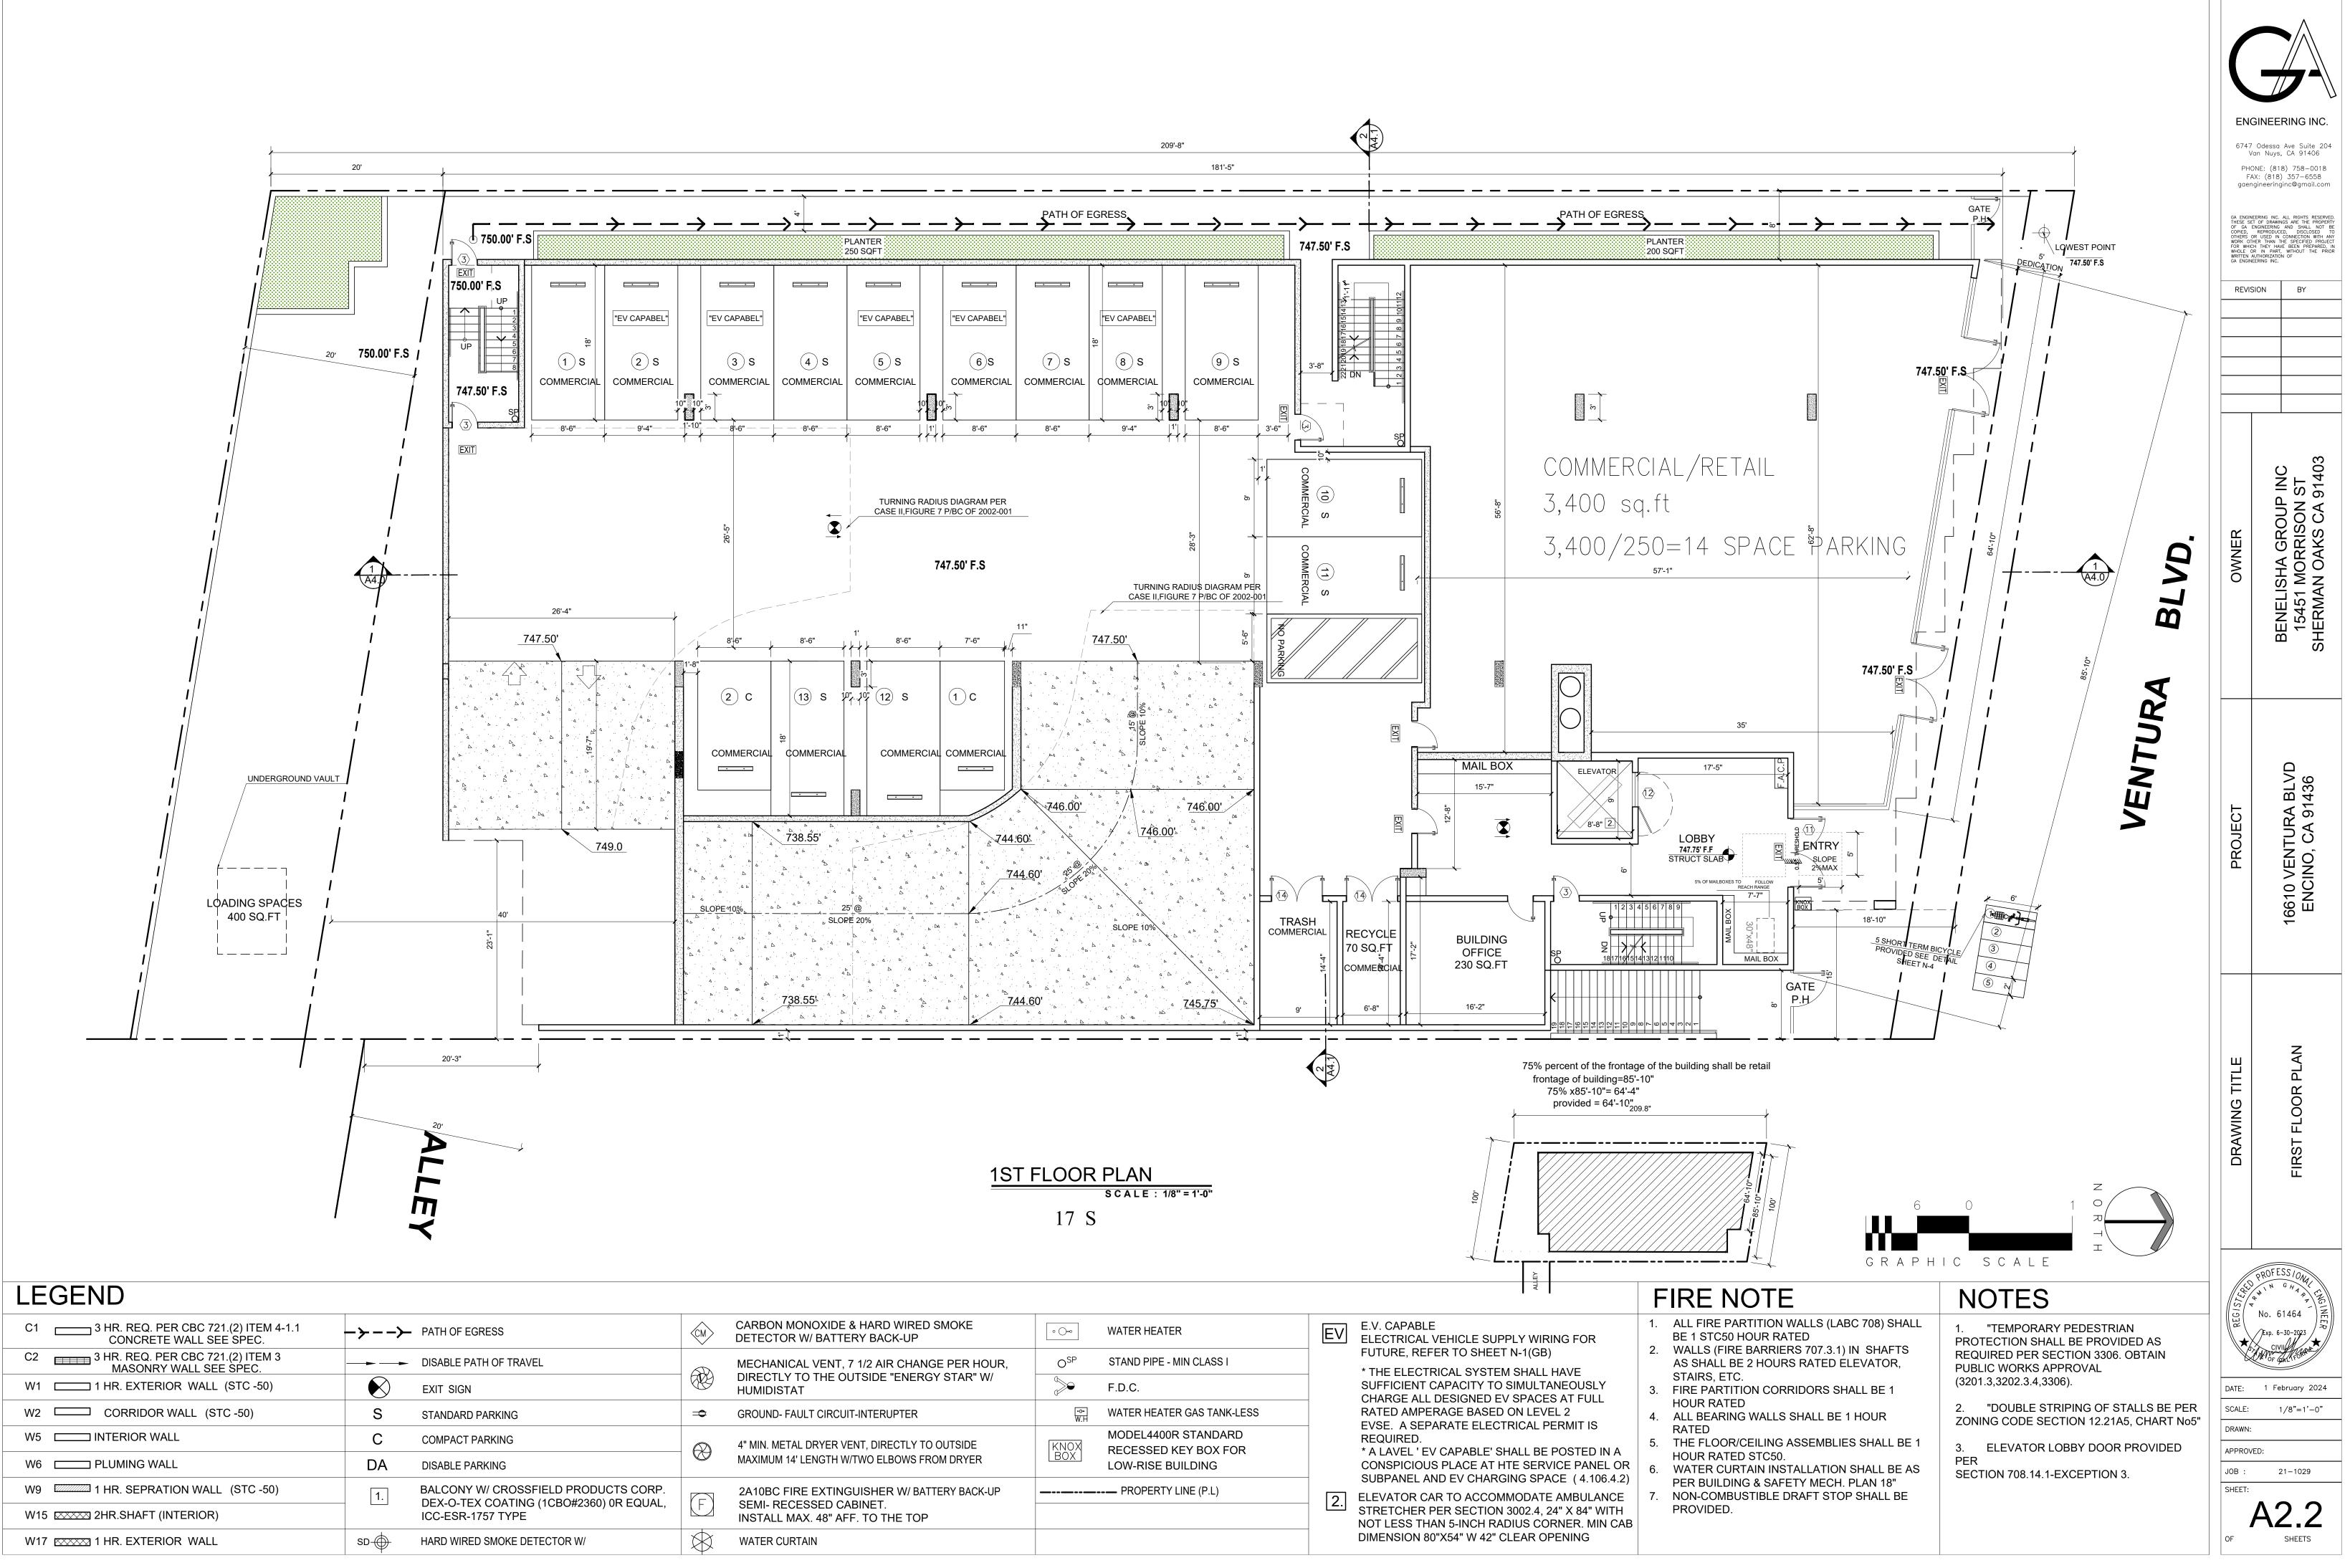

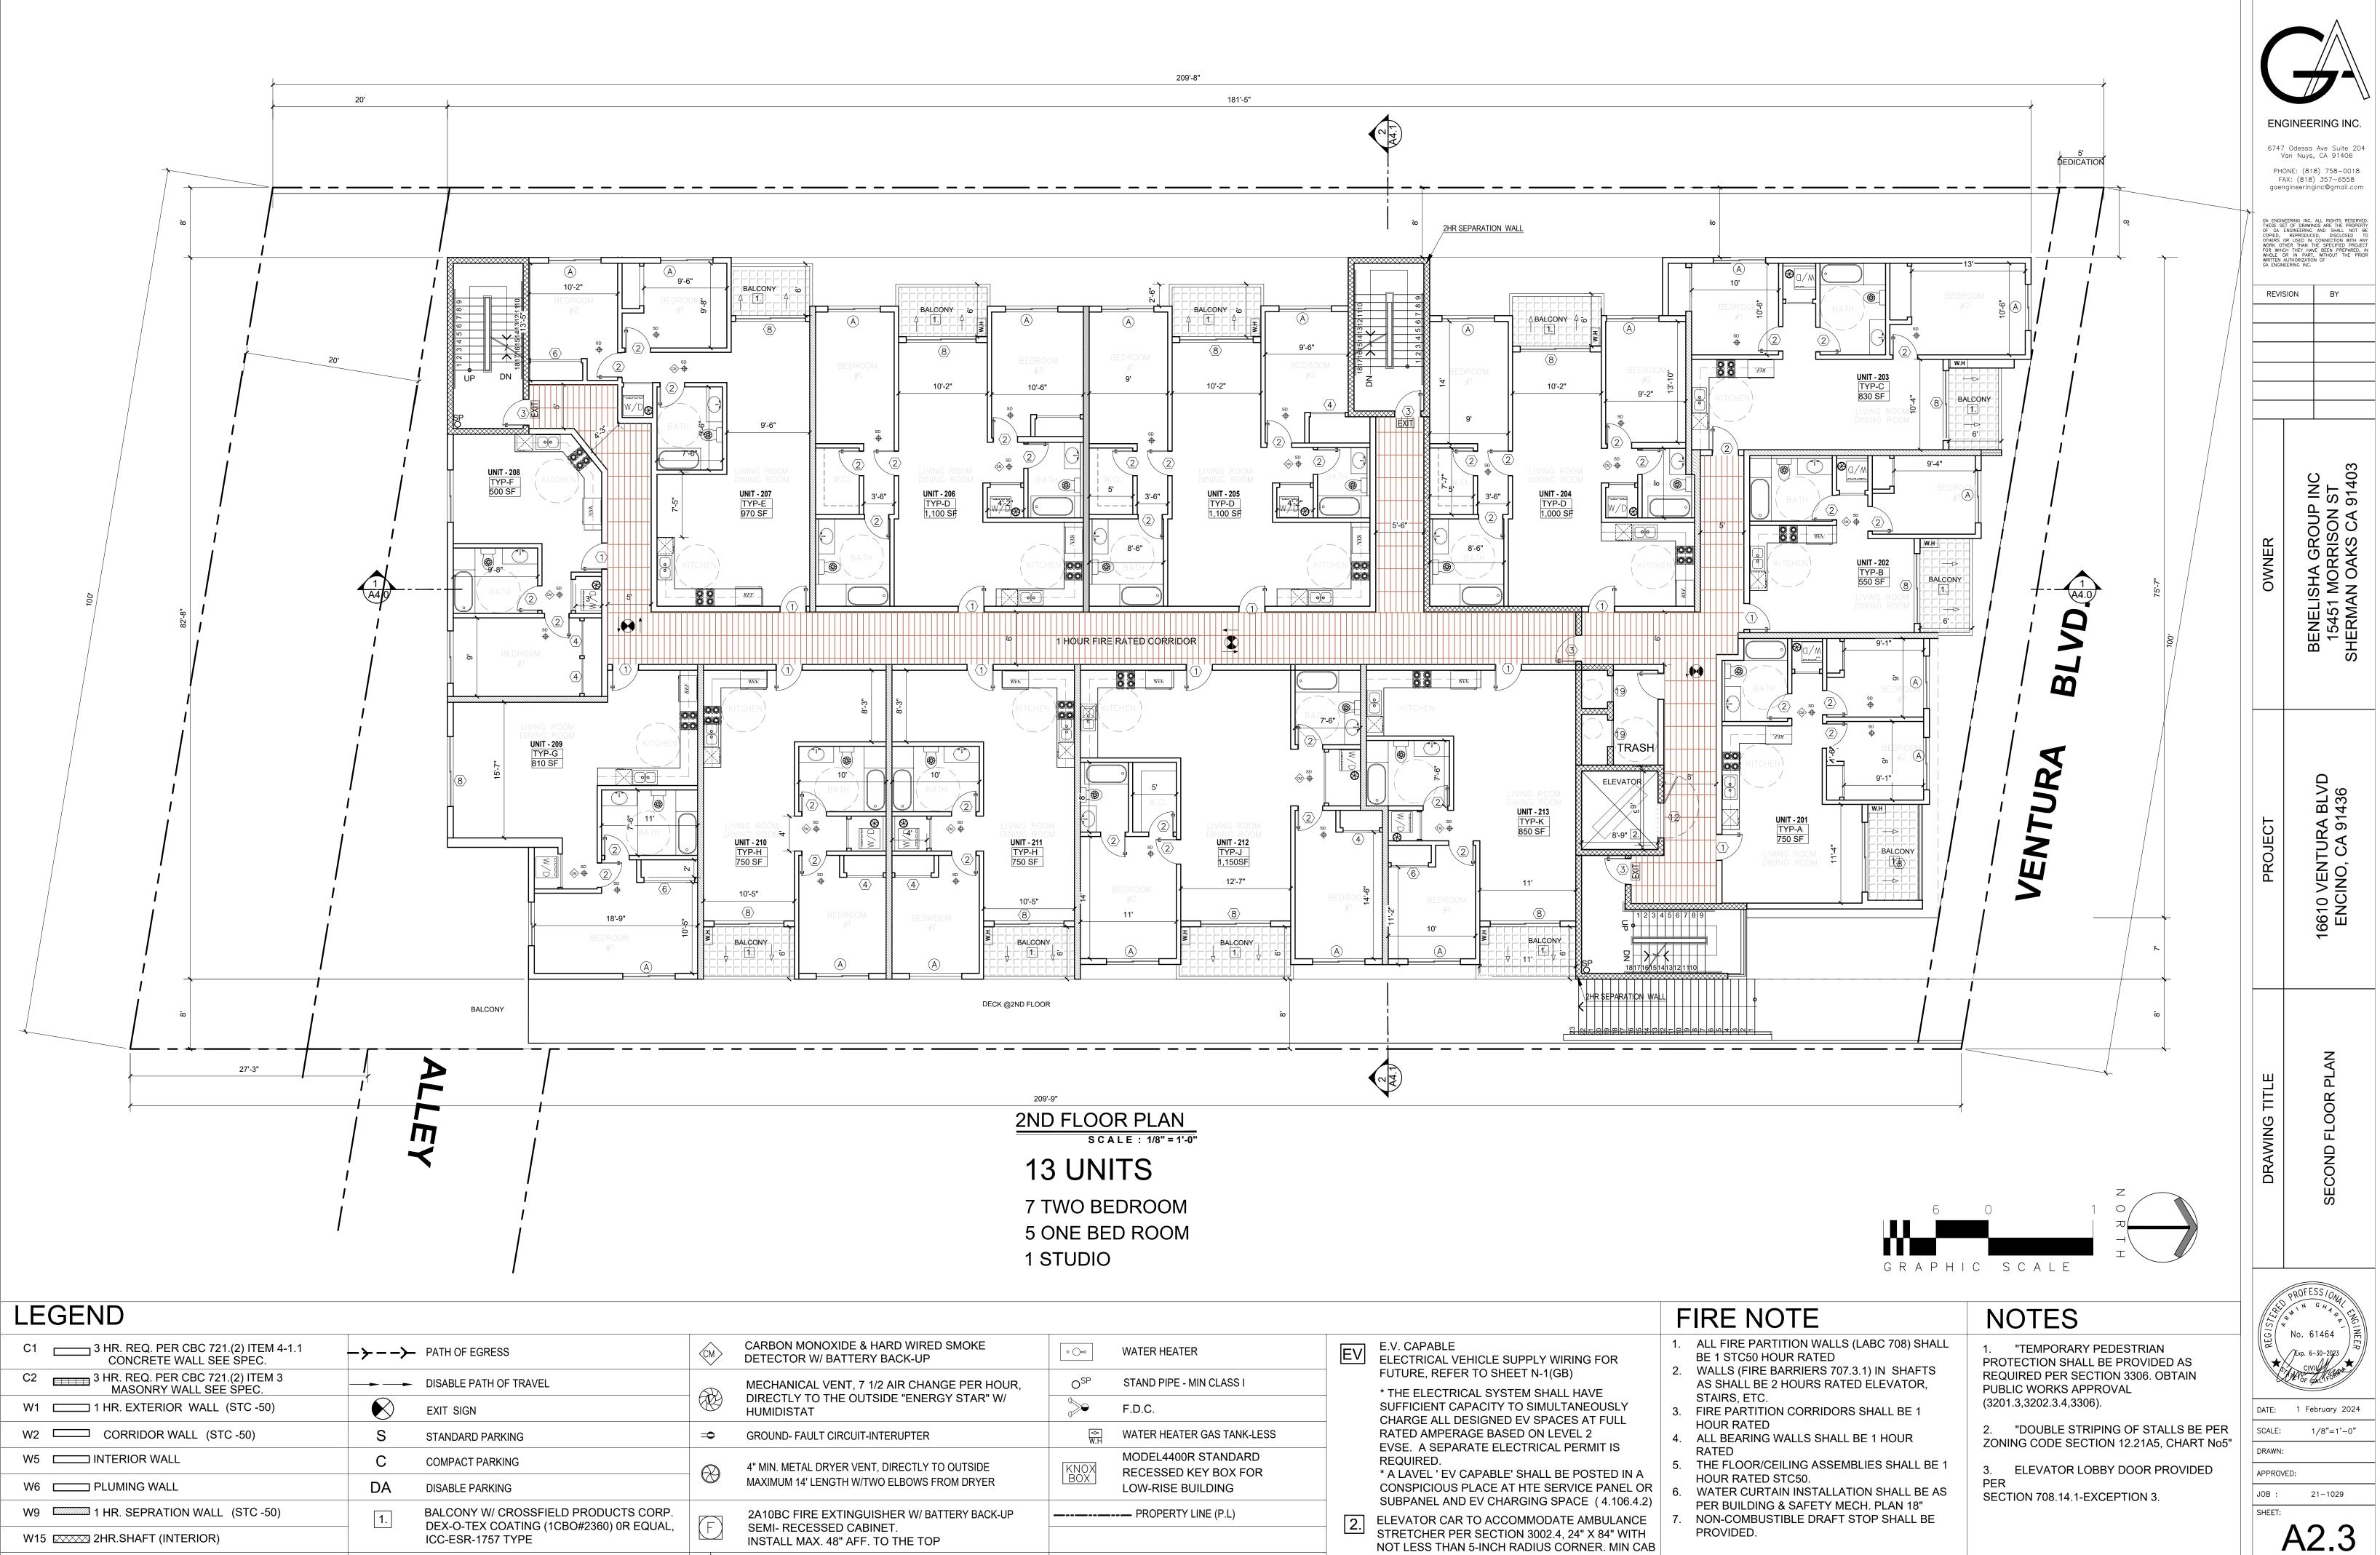

DIMENSION 80"X54" W 42" CLEAR OPENING

SHEETS


W17 XXXXX 1 HR. EXTERIOR WALL


SD-


HARD WIRED SMOKE DETECTOR W/


WATER CURTAIN

 $\bigotimes$ 

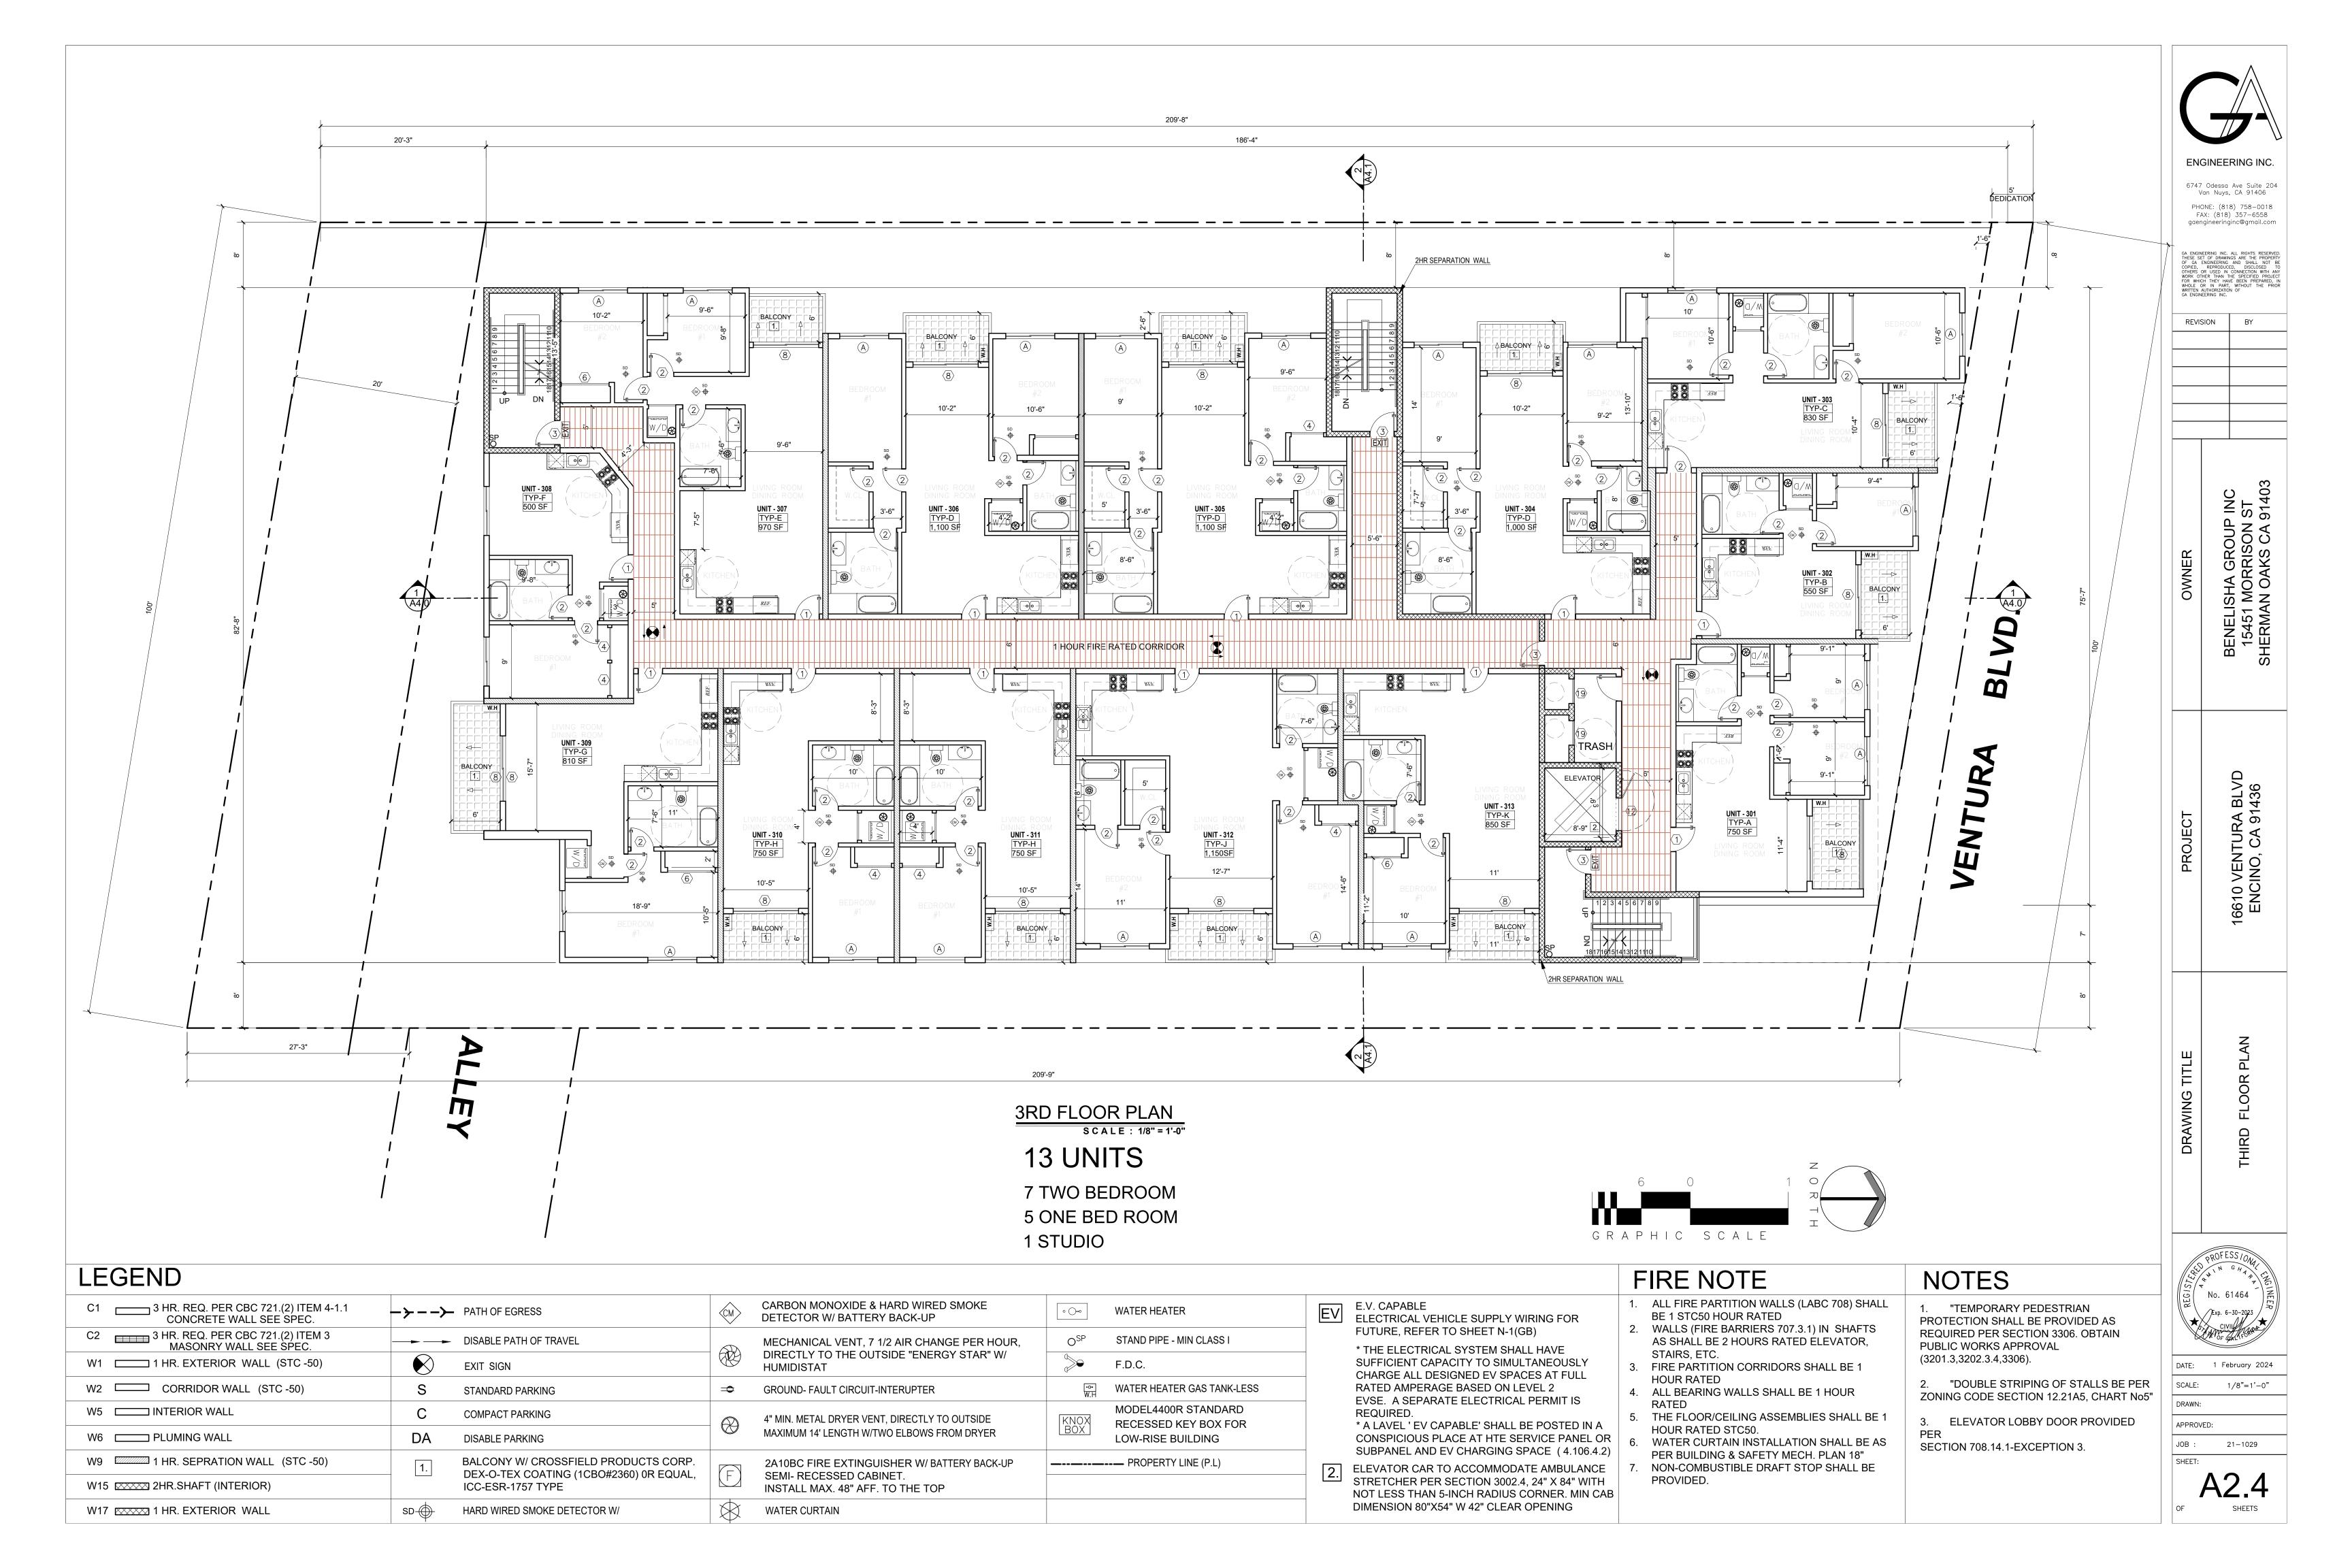


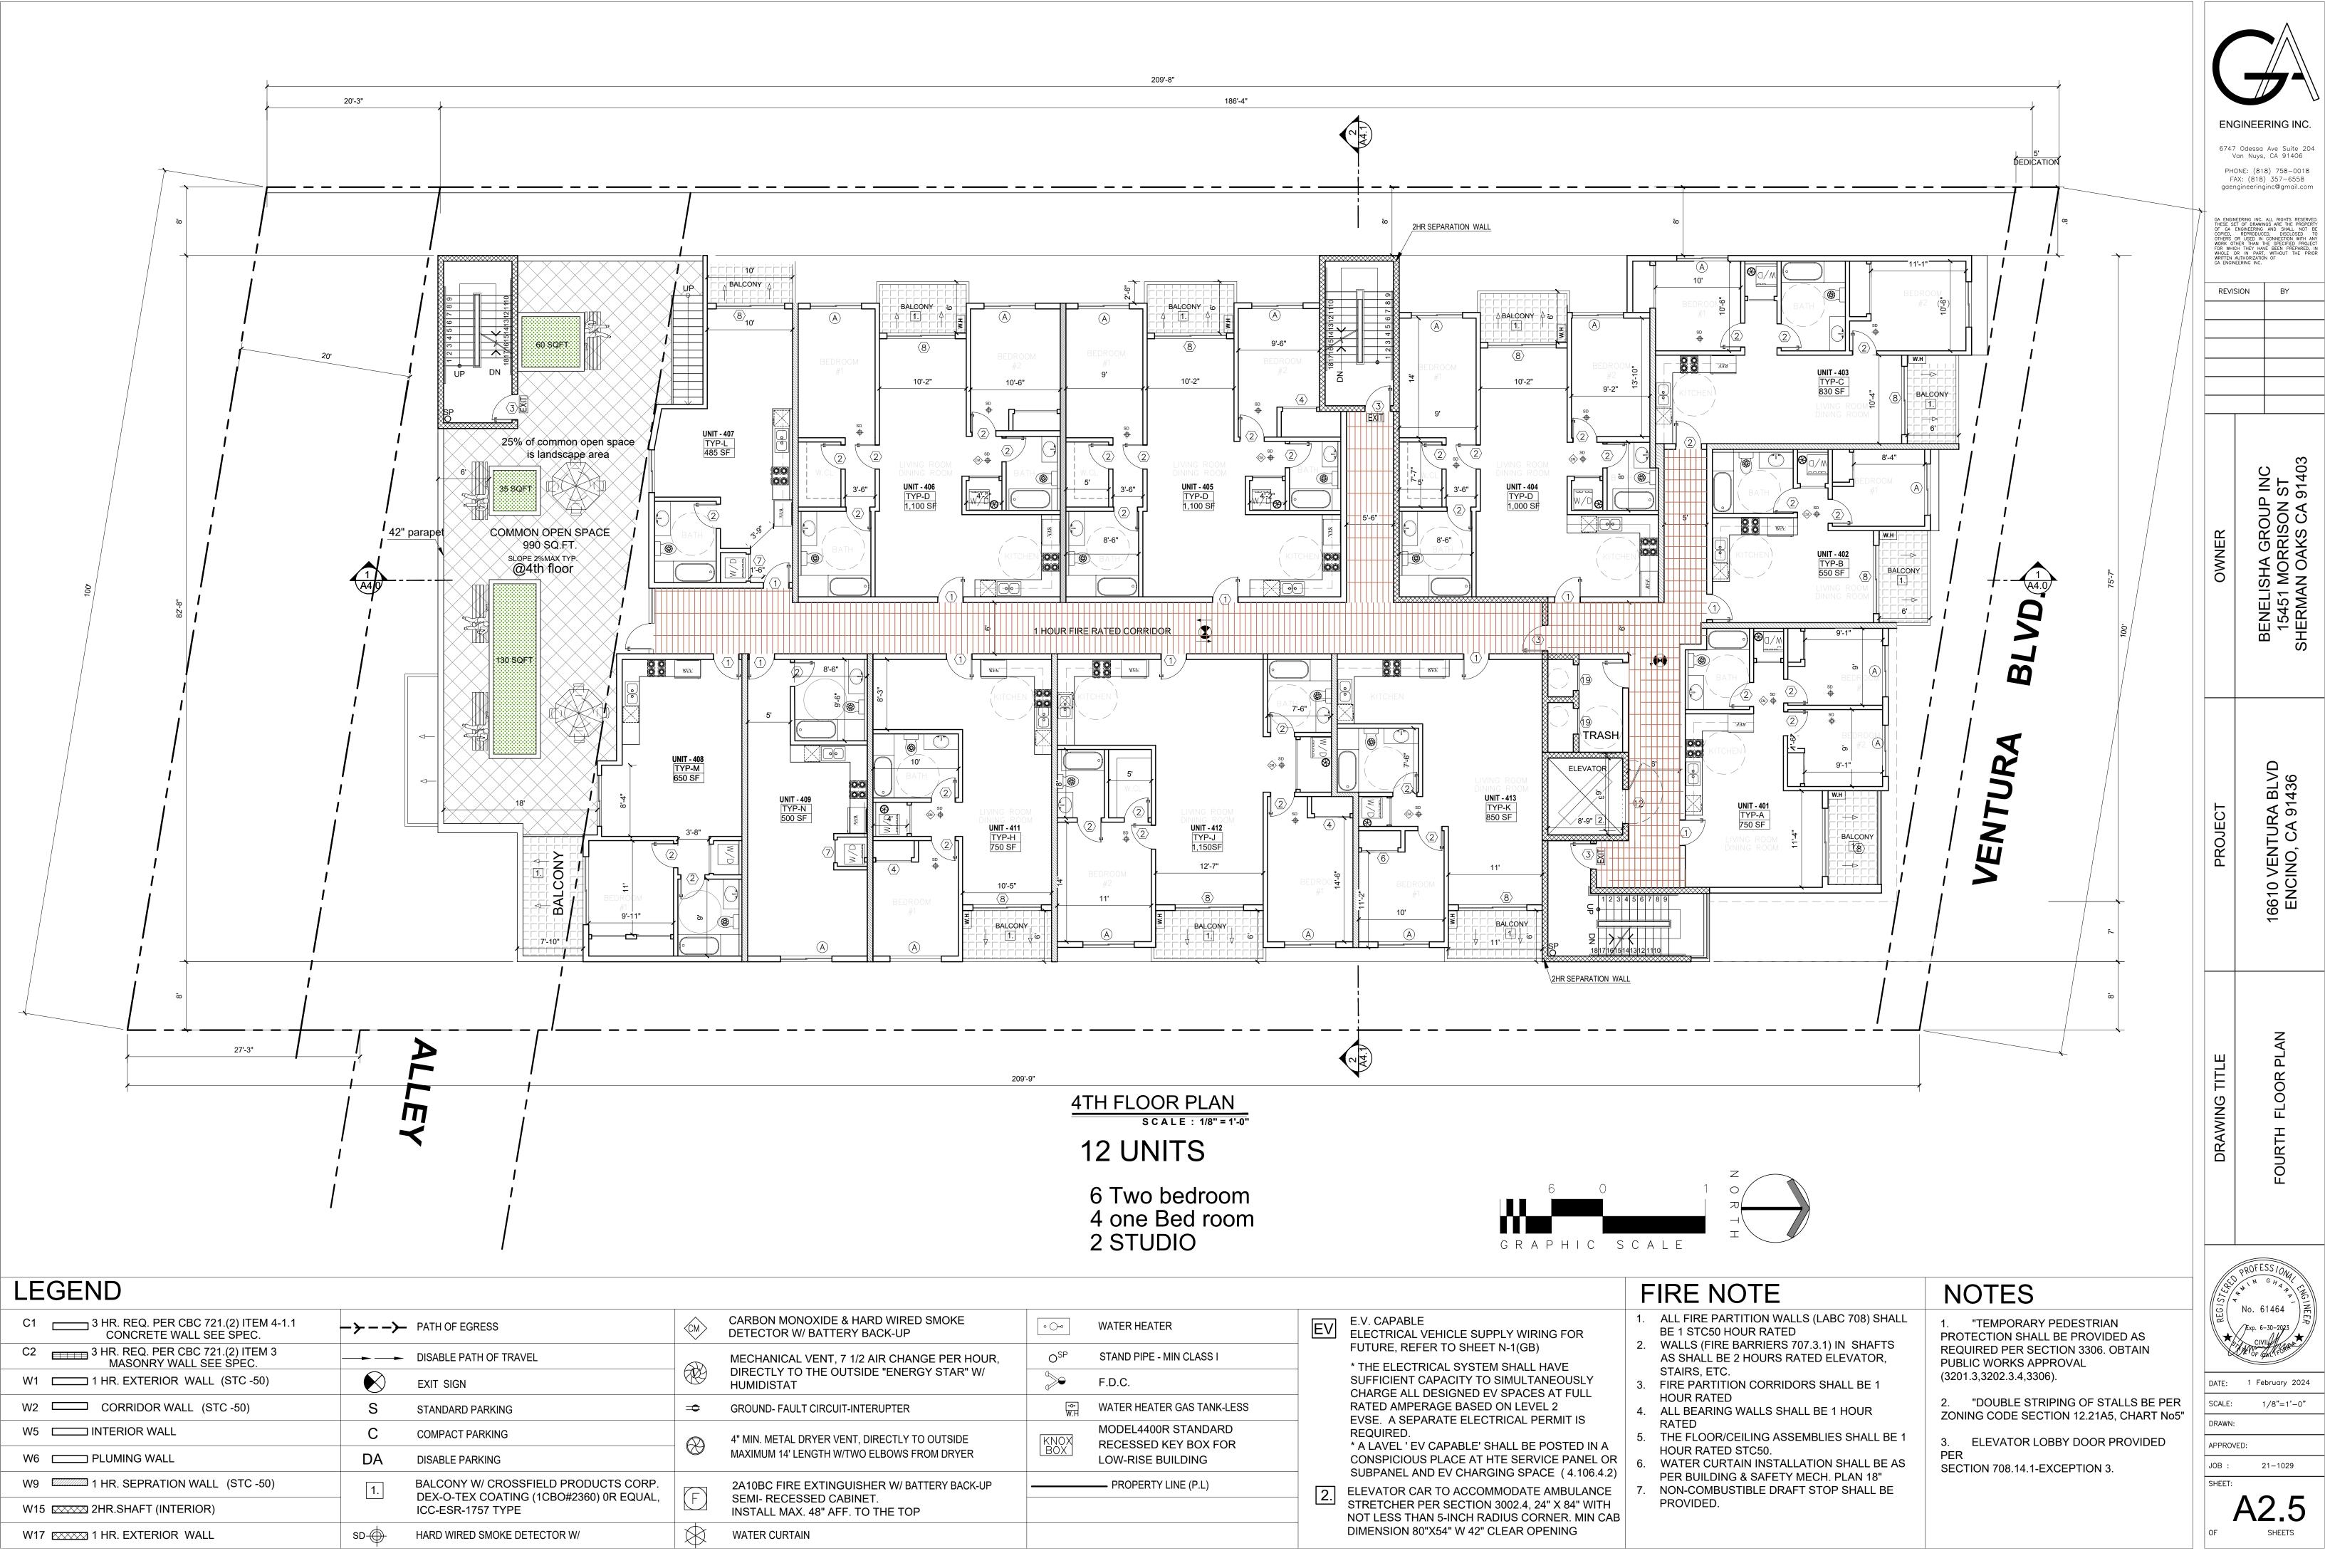


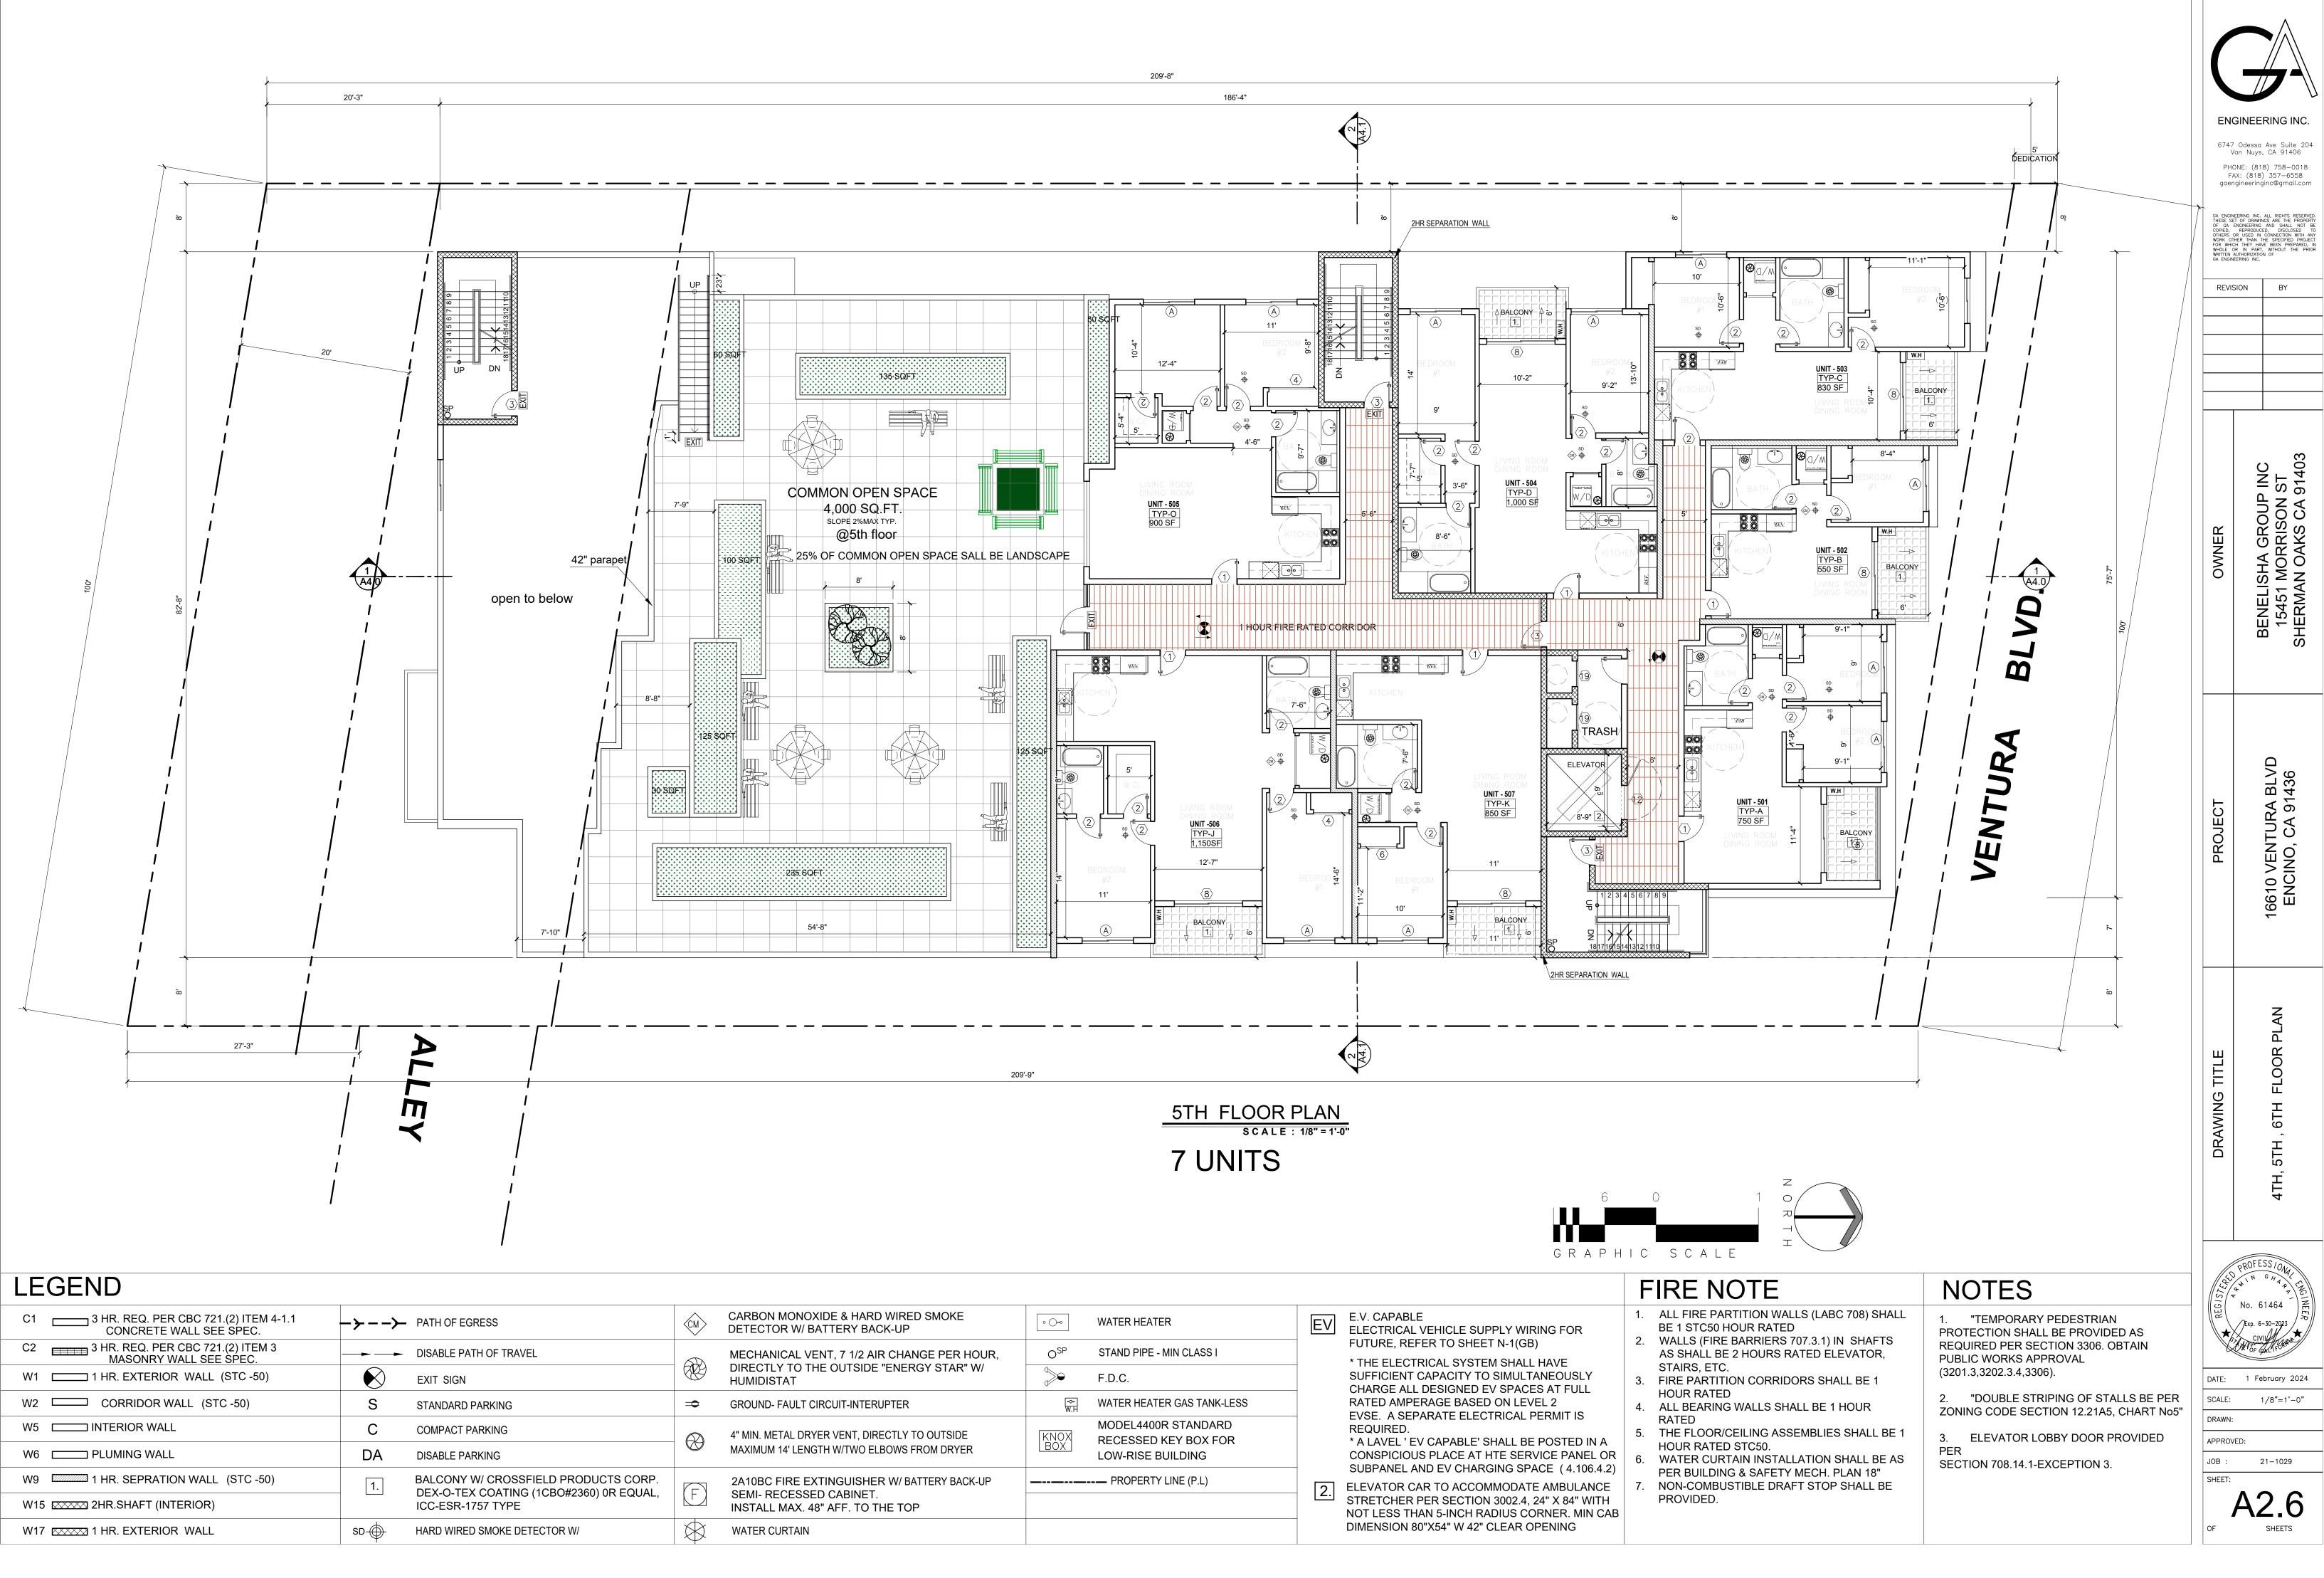

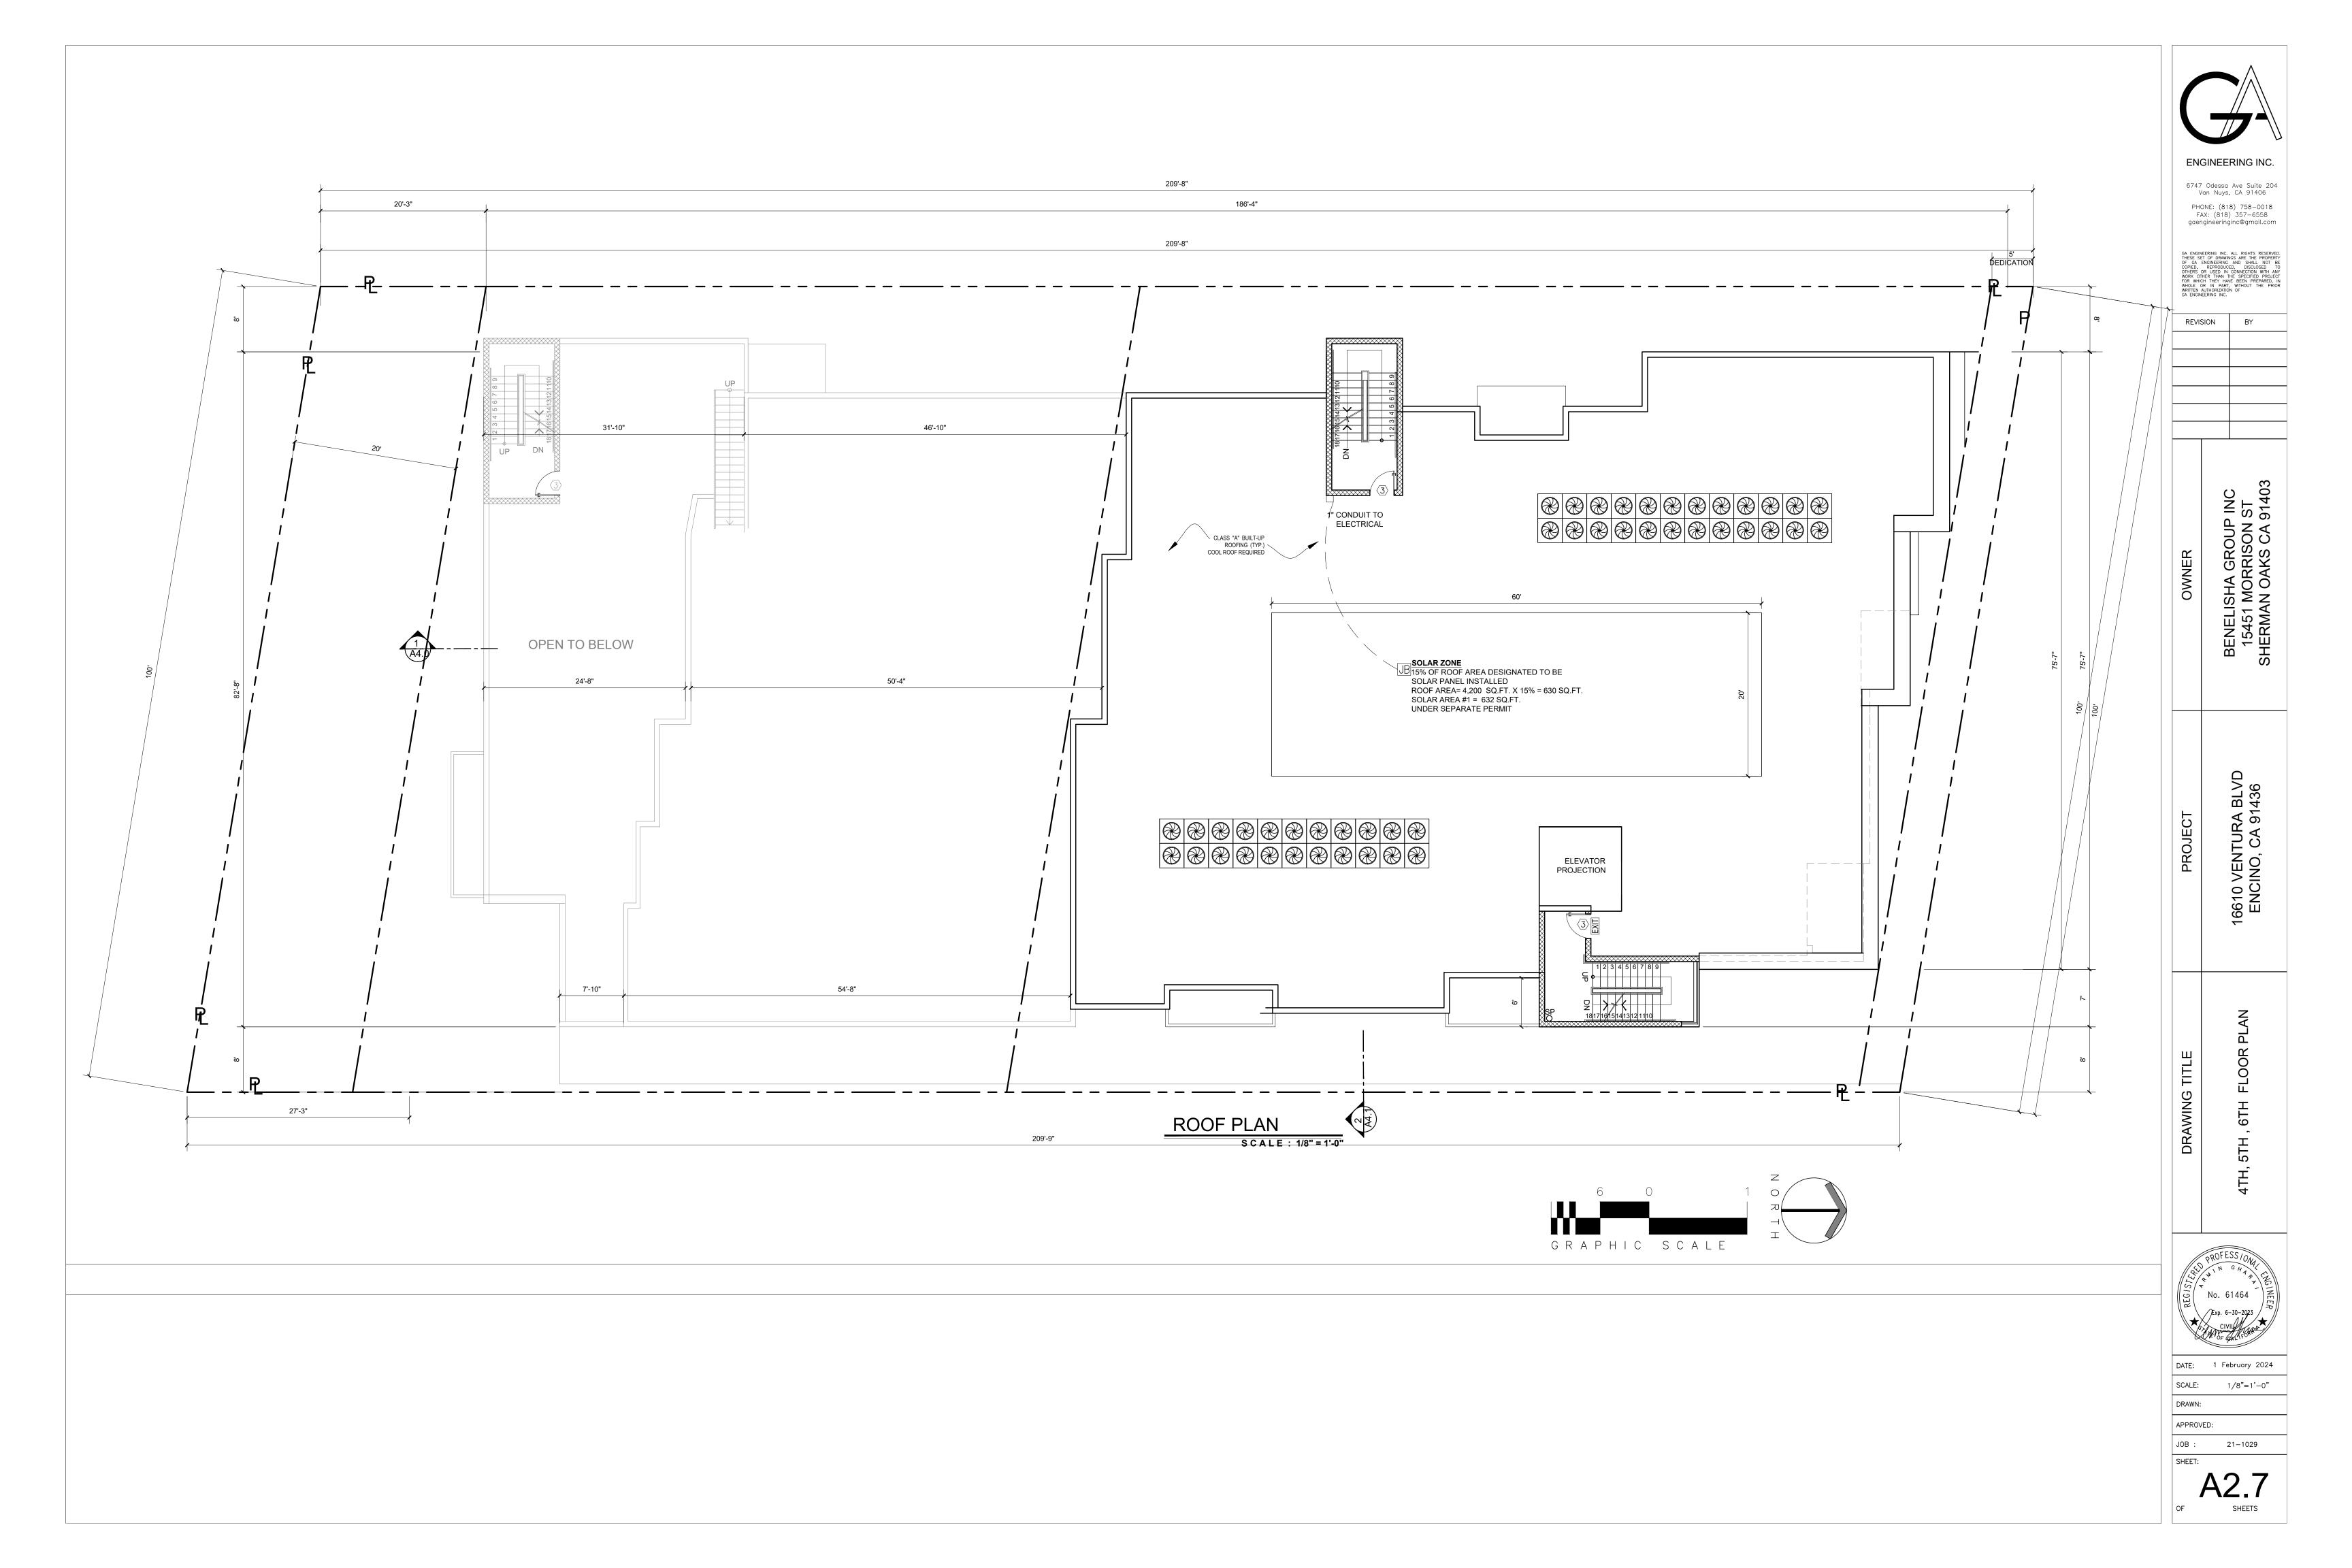



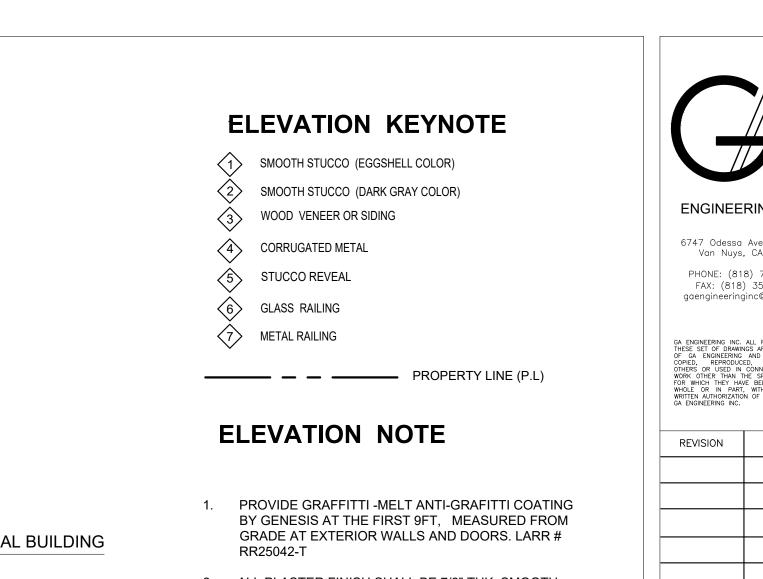

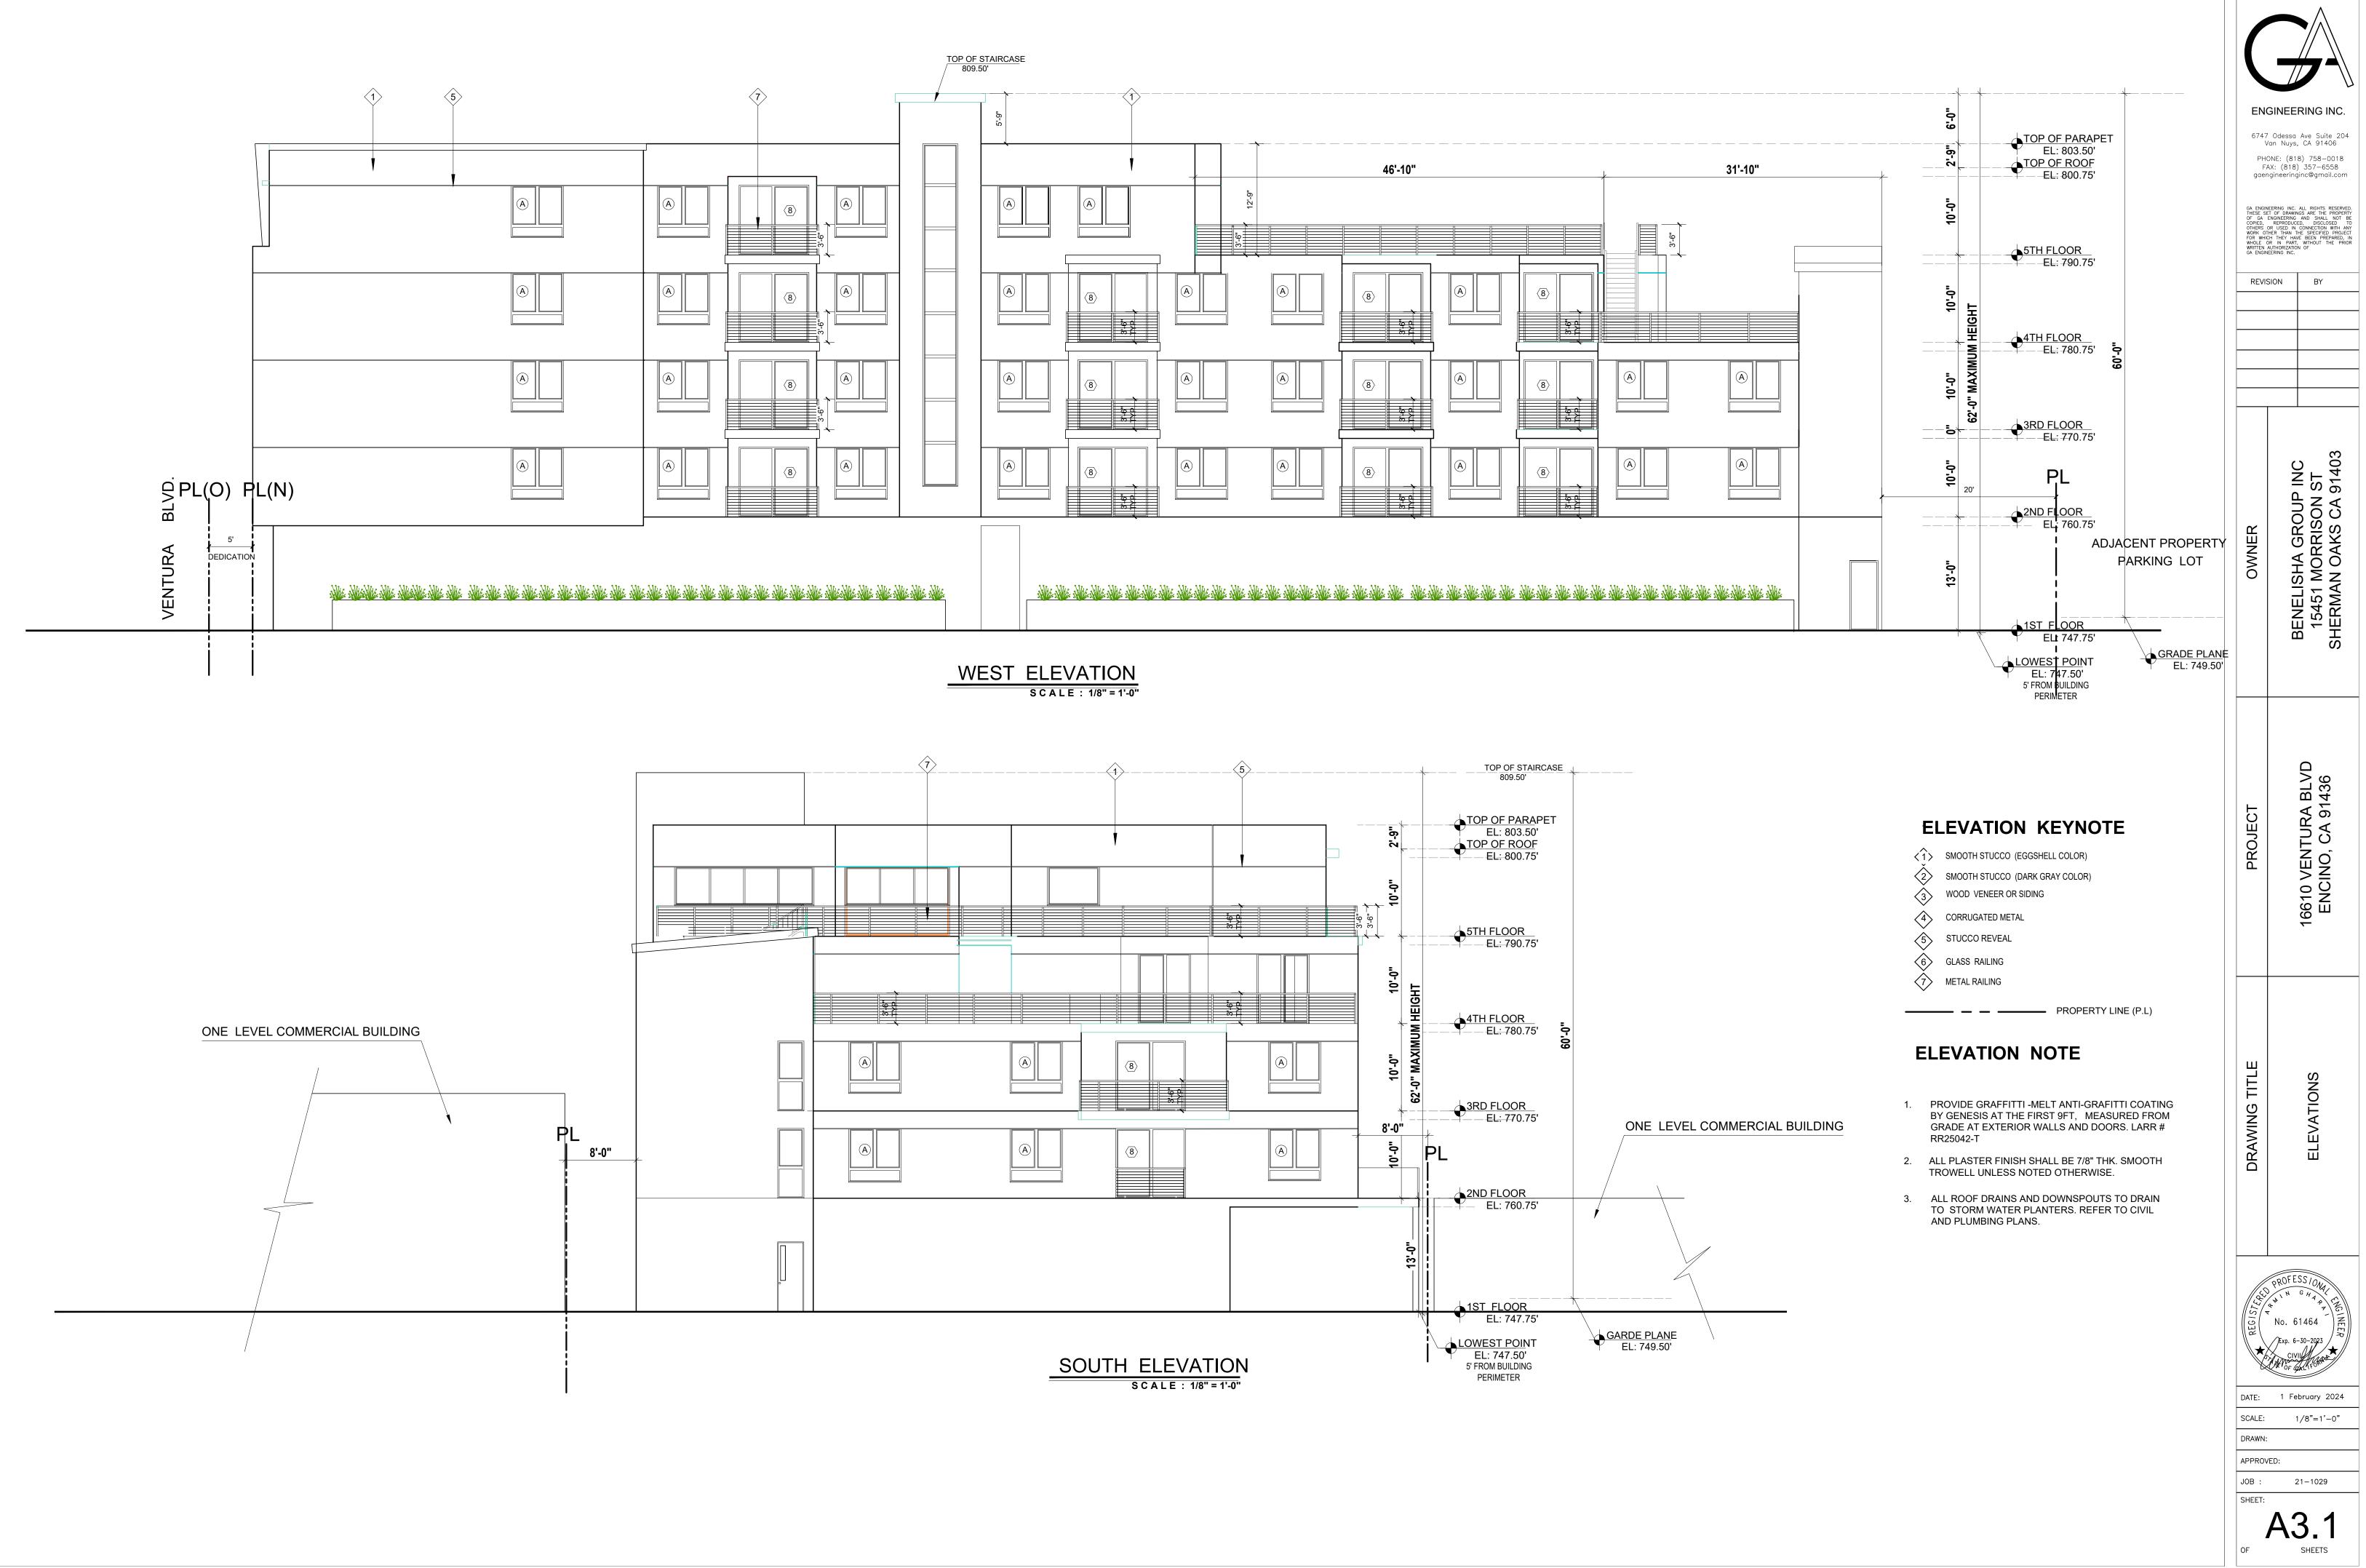



# NORTH ELEVATION

SOUTH ELEVATION

DATE:

SCALE:

DRAWN:

SHEET:

OF

APPROVED:

JOB : 21-1029

A3.2

SHEETS

1 February 2024

1/8"=1'-0"





## **ELEVATION KEYNOTE**

- SMOOTH STUCCO (EGGSHELL COLOR)
- SMOOTH STUCCO (DARK GRAY COLOR)
- 3 WOOD VENEER OR SIDING
- CORRUGATED METAL
- 5 STUCCO REVEAL 6 GLASS RAILING
- METAL RAILING



ENGINEERING INC.

6747 Odessa Ave Suite 204 Van Nuys, CA 91406 PHONE: (818) 758-0018 FAX: (818) 357-6558 gaengineeringinc@gmail.com

REVISION ΒY BENELISHA GROUP INC 15451 MORRISON ST SHERMAN OAKS CA 91403 OWNER 16610 VENTURA BLVD ENCINO, CA 91436 PROJECT **EVATIONS** DRAWING TITLE Ш RED Ð. COL No. 61464 DATE: 1 February 2024 1/8"=1'-0" SCALE: DRAWN: APPROVED: JOB : 21-1029 SHEET: A3.3

SHEETS

OF

EAST ELEVATION

WEST ELEVATION





NORTH ELEVATION / VIEW FROM VENTURA

