


16610-16618 W VENTURA BLVD, LOS ANGELES CA 91436

		IDDIU-IDDIO VV VEINIURA DLVD, LUS AI	1
PROJECT ADDRESS	INDEX ARCHITECTURAL	PROJECT DATA NEW MIXED-USE, COMMERCIAL RESIDENTIAL BUILDING. FIRST FLOOR COMMERCIAL AND	PARKING CALCULATION PARKING REQUIRED PER LAMC 12.22.A25 OPTION1
16610-16618 W VENTURA BLVD, LOS ANGELES, CA 91436	SHEET TITLE T.O COVER SHEET	PROPOSED: PARKING, 4-RESIDENTIAL STORIES (45) UNITS, 5 STORIES IN TOTAL OVER 2- LEVEL BASEMENT PARKING	# OF AUTO UNITS PARKING TOTAL
PROJECT OWNER	T1.1DIAGRAMS, B&C CODE ANALYSIST1.2DIAGRAMS, B&C CODE ANALYSIST1.3DIAGRAMS, B&C CODE ANALYSIST1.4FLOOR AREA RATIO	LEGAL DESCRIPTION PORTION OF LOT 4, ARB 1&2, BLOCK 11 TRACT NO. 2955, IN THE CITY OF LOS ANGELES, COUNTY OF LOS ANGELES, STATE OF CALIFORNIA AS PER MAP RECORDED IN M.B. 31, PAGE 62-70 OF MAPS, IN THE OFFICE OF THE COUNTY RECORDER OF SAID COUNTY.	STUDIO 4 1 4 1- BDRM 17 1 17 2- DDDM 24 1.5 76
BENELISHA GROUP INC	T1.5 OPEN SPACE DIAGRAM A1.0 SITE PLAN	APN: 2284-007-001 (ARB1) , 2284-007-026(ARB2)	2- BDRM 24 1.5 36 TOTAL 45 57
15451 MORRISON ST SHERMAN OAKS CA 91403	A2.0 BASEMENT PLAN A2.1 FIRST FLOOR PLAN	ZONE: C4-1L	PROVIDED FOR RESIDENTIAL
PHONE: (818) 787.8911	A2.2SECOND FLOOR PLANA2.3THIRD FLOOR PLANA2.4FOURTH FLOOR PLAN	AREA AND BUILDING CALCULATIONS	PARKING No. STANDARD 49
DESIGN BY	A2.5 FIFTH FLOOR PLAN A2.6 SIXTH FLOOR PLAN A2.7 ROOF PLAN	TYPE OF CONSTRUCTION:2- BASEMENT LEVELANDFIRST FLOOR TYPE I-A GARAGE FULLY SPRINKLERED (NFPA-13). SECOND FLOOR TO FIFTH FLOOR TYPEV-A FULLY SPRINKLERED THROUGHOUT (NFPA-13).	STANDARD49COMPACT13DISABLE PARKING1
G.A. ENGINEERING LIC# C61464 6747 ODESSA AVE. SUITE 204	A3.0 ELEVATIONS A3.1 ELEVATIONS	OCCUPANCY GROUP R-2 / S-2 PARKING	TOTAL AUTO PARKING RESIDENTS63SHORT-TERM BICYCLE PARKING REQUIRED= 5 SPACES , PROVID
VAN NUYS, CA. 91406 PHONE: (818)758-0018	A3.2COLOREDELEVATIONSA3.3COLOREDELEVATIONSA3.4COLOREDELEVATIONS(FROM ADJACENT)A4.0SECTIONS	LOT AREA: 10,365.6 SQ.FT + 10,388.8 SQ.FT = 20,754.4 (PER ZIMAS). STORIES: 5 STORIES	LONG TERM BICYCLE REQUIRED= 45 SPACES, PROVIDED 45
STRUCTURAL ENGINEER	A5.0 DOORS & WINDOWS SCHEDULE	- STORIES: 5 STORIES INTERIOR SIDE YARDS: 0'-0" AT FIRST FLOOR, 8 FEET FROM 2ND- 5TH FLOOR	" NO GUEST PARKING" 2% of number of parking= 2%x63 =1.26=2 accessible park
G.A. ENGINEERING LIC# C61464		BUILDING SETBACKS REQUIRED : FRONT YARD : MINIMUM 18" FEET, MAXIMUM 10 FEET	EV PARKING= 30% X 63 =19 EV PARKING PROVIDED EV PARKING
6747 ODESSA AVE. SUITE 204 VAN NUYS, CA. 91406 PHONE: (818)758-0018		REAR YARD : 20 FEET	10%X19 =1.9 =2 EVCS PARKING (INSTALL CHARGER REQUIRED)
		BUILDING SETBACKS PROVIDED : FRONT YARD + 18" FEET	17 EVCAPABLE COMMERCIAL AUTO PARKING REQUIRED
SURVEY A.J.A		BUILDING SETBACKS PROVIDED : FRONT YARD : 18" FEET REAR YARD : 20 FEET	FLOOR AREA USE RATE TOTAL
7411 FLORENCE AVE, DOWNEY CA 90240		ALLOWABLE BUILDING HEIGHT: 45 FEET	3,400 SQ,FT, COMMERCIAL 3,400/250 . 12 STANDA (RETAIL) SQ.FT. 2 COMAPCT
PHONE: (562)760-6040		62 FEET MAXIMUM HEIGHT	TOTAL PROVIDED 14
GEOTECHNICAL ENGINEER		PROPOSED BUILDING HEIGHT: OFF MENU INCENTIVE OF 11 FEET HEIGHT INCREASE PER LAMC 12.22.A25 + 6 FEET STAIRCASE PROJECTION	SHORT-TERM BICYCLE PARKING REQUIRED=1 PER 2,000 (MINIMUM PROVIDED SHORT TERM = 2 SPACES
A.G.I GEOTECHNICAL INC		PER SPECIFIC PLAN WITH TOTAL HEIGHT PROVIDED 62 FEET	LONG-TERM BICYCLE PARKING REQUIRED=1 PER 2,000 (MINIMUM PROVIDED LONG TERM = 2 SPACES
16555 SHERMAN WAY , SUIT A VAN NUYS, CA. 91406 PHONE: (818)758–0018		AREA SUMMARY (LABC)	OPEN SPACE CALCULATION
LANDSCAPING		STORY OCC. USE A A B C D A-B-C A-B-C-D AREA: AREA: AREA: VENTILATION AREA: STAIRWAYS AREA AREA AREA: AREA	REQUIRED NO. OF HABITABLE QUANTITY
SARMEN INC	L-1FIRST FLOORPLANTING PLANL-2FOURTH FLOORPLANTING PLAN	BASEMENT-2 ^{S-2} PARKING I-A 15,150 EXTERIOR WALLS SHAFT SQ.FT. SQ.FT. SQ.FT. (SQ.FT.)	BEDROOMSROOMSOF UNITSOPEN SPACESTUDIO244 X 100 = 400
10847 WESCOTT AVE SUNLAND , CA. 91040 PHONE: (818)482-3737	L-3FIFTH FLOORPLANTING PLANL-4PLANTING NOTES AND DETAILS	BASEMENT-2 S-2 PARKING I-A 15,150	1 2 17 17X 100 = 1,700
FROME. (818)482-3737	L-5IRRIGATION NOTES AND LEGENDSL-6FIRST FLOOR IRRIGATION PLANL-7FOURTH FLOOR IRRIGATION PLAN	FIRST S-2 PARKING I-A 9,500 R-2 COMMERCIAL(retail) I-A 3,400 C 2 COMMERCIAL(retail) I-A 3,400 C 2 COMMERCIAL(retail) I-A 3,400 C 2 COMMERCIAL(retail) I-A 3,400 C 2 C 2 C 2 C 2 C 2 C 2 C 2 C 2 C 2 C 2	2 3 24 24X 125 = 3,000 TOTAL REQUIRED 5,100 SQ.FT
ELECTRICAL ENGINEER	L-8 FIFTH FLOOR IRRIGATION PLAN L-9 IRRIGATION DETAILS	R-2 LOBBY III-A 1,450 ~ ~ 1,450 1,450	
	L-10IRRIGATION DETAILSL-11IRRIGATION SPECIFICATIONSL-12PLANTING SPECIFICATIONS	SECOND R-2 RESIDENTIAL III-A 13,400 400 100 760 12,900 12,140 THIRD R-2 RESIDENTIAL III-A 13,400 400 100 760 12,900 12,140	PROVIDED
	L-13 PLANTING SPECIFICATIONS	THIRD R-2 RESIDENTIAL III-A 13,400 400 100 760 12,900 12,140 FOURTH R-2 RESIDENTIAL III-A 11,600 400 100 760 12,900 12,140	AREA DESCRIPTION OPEN SPACE
		FIFTH R-2 RESIDENTIAL III-A 7,600 250 100 760 7,250 6,490	DECK © 5TH FLOOR 4,000 SQ.FT. DECK © 4TH FLOOR 990 SQ.FT.
MECHANICAL & PLUMBING ENGINEE	R <u>s-0</u> s-0A	TOTAL S-2 39,800	BALCONY28X501,400SQ.FT.TOTALPROVIDED6,390SQ.FT.
	S-1 S-2 S-3	ALLOWABLE R-2 49,000 45,960	
	S-4 S-5 S-6	SCHOOL DISTRICT ASSESSABLE ALLOWABLE FLOOR AREA CALCULATION (LAMC)	DENSITY CALCULATION
	S-7 S-8	LOT AREA: 20,754.4 SQ.FT. (PER SURVEY)	
	S-9 SD-1 TO	STORY USE AREA (SQ.FT.) ZONE: C4-1 VL	BUILDABLE AREA:
	SD-10 SH-0 SH-1	FIRST DWELLING UNITS 3,400+1,100 BUILDABLE AREA SHALL HAVE THE SAME MEANING SECOND DWELLING UNITS 13,400 AS LOT AREA AT C4 ZONE	C4-1VL ZONE
	SH-2 SH-3	THIRD DWELLING UNITS 13,400 AS LOT AREA AT C4 ZONE BUILDABLE AREA: 20,754.4 SQ.FT.	
	SH-4 SH-5	FOURTH DWELLING UNITS 11,600 FIFTH DWELLING UNITS 7,600 FAR: 1.5:1 FOR MIXED USE	209.71'
	CIVIL	TOTAL 50,500 ALLOWABLE FLOOR AREA PER SPECIFIC PLAN:	LOT AREA: 20,754.4 SQ.FT. (PER SURVEY)
	C0COVER SHEETC-1.0BASEMENT-2GRADING PLANC-1.1BASEMENT-1GRADING PLAN	20,754 SQ.FT. X 1.5 =31,131 SQ.FT	BUILDABLE AREA SHALL HAVE THE SAME MEANING AS LOT AREA AT C
	C12 FIRST FLOOR GRADING PLAN C-1.3 SECTIONS	OFF MENU INCENTIVE (REQUEST FOR F.A.R) FAR: 2.3 :1	DENSITY =1 UNIT/400 SQ.FT
		20,754.4 SQ.FT. X2.3=47,735.1 SQ.FT > 45,960 SQ.FT (PROVIDED)	ALLOWABLE BASE UNITS=20,754.4/400 =51.88 = 52 UNIT
		AREA PER UNIT	MAXIMUM ALLOWABLE DENSITY BONUS IS = 1.35%X52= 71 UNIT
			PROPOSED UNITS= 45 UNIT TO QUALIFY FOR 3 ADDITIONAL INCENTIVES =
		$\begin{array}{ c c c c c c c c c c c c c c c c c c c$	52(BASE DENSITY) X 15% = 7.8 = 8 UNITS ALLOCATED TO
		201 2 BED/1 - BATH 501 2 BED/1 - BATH 601 2 BED/1 - BATH 500 202 1 - BED/1 - BATH 550 302 1 - BED/1 - BATH 550 402 1 - BED/1 - BATH 550 503 2 - BED/2 - BATH 830	VERY LOW INCOME TENANTS 52 X 15% = 8 UNITS ALLOCATED TO VERY LOW INCOME TENANTS
		203 2-BED/2-BATH 830 303 2-BED/2-BATH 830 403 2-BED/2-BATH 830 204 2-BED/2-BATH 1,000 304 2-BED/2-BATH 1,000 404 2-BED/2-BATH 1,000 205 2 BED/2-BATH 1,000 404 2-BED/2-BATH 1,000 505 2-BED/2-BATH 900	REQUESTED ENTITLEMENTS:
		205 2-BED/2-BATH 1,100 305 2-BED/2-BATH 1,100 405 2-BED/2-BATH 1,100 506 2-BED/2-BATH 1,100 206 2-BED/2-BATH 1,100 306 2-BED/2-BATH 1,100 406 2-BED/2-BATH 1,100 506 2-BED/2-BATH 1,100 207 2-BED/2-BATH 970 307 2-BED/2-BATH 970 407 STUDIO/1BATH 485 FIFTH FLOOR = 7 UNITS	1) OFF MENU INCENTIVE OF 11 FEET HEIGHT INCREASE PER LAMC 12.2 AFFORDABLE HOUSING + 6 EXTRA HEIGHT FOR STAIR CASE PROJEC
		208 STUDIO/1-BATH 500 308 STUDIO/1-BATH 500 408 1-BED/1-BATH 650 209 1-BED/1-BATH 810 309 1-BED/1-BATH 810 409 STUDIO/1BATH 500	PER SPECIFIC PLAN TOTAL 17 FEET HEIGHT INCREASE 2) OFF MENU INCENTIVE FOR FLOOR AREA INCREASE FROM 1.5:1 TO 2
		210 1-BED/1-BATH 750 310 1-BED/1-BATH 750 410 1-BED/1-BATH 750 211 1-BED/1-BATH 750 311 1-BED/1-BATH 750 411 1-BED/1-BATH 1,150	PER LAMC 12.22.A25, AFFORDABLE HOUSING
		212 2-BED/2-BATH 1,150 312 2-BED/2-BATH 1,150 412 1-BED/1-BATH 850 213 1-BED/1-BATH 850 313 1-BED/1-BATH 850 412 1-BED/1-BATH 850 2ND FLOOR = 13 UNITS 3RD FLOOR PLAN = 13 UNITS 4TH FLOOR PLAN = 12 UNITS	3) OFF-MENU INCENTIVE, IN THE REGIONAL COMMERCIAL PLAN DES AREA, BUILDINGS ABUTTING A MAJOR OR SECONDARY HIGHWAY EXCEED 45 FEET IN HEIGHT, IF, FOR EACH 10 FOOT INCREMENT 45 FEET, AT LEAST A TEN FOOT SETBACK FROM THE ROOF PER
			IS PROVIDED. 4) WAIVER OF TRANSITION HEIGHT AS REQUIRED BY LAMC 12.21.1A.10
L	1		1

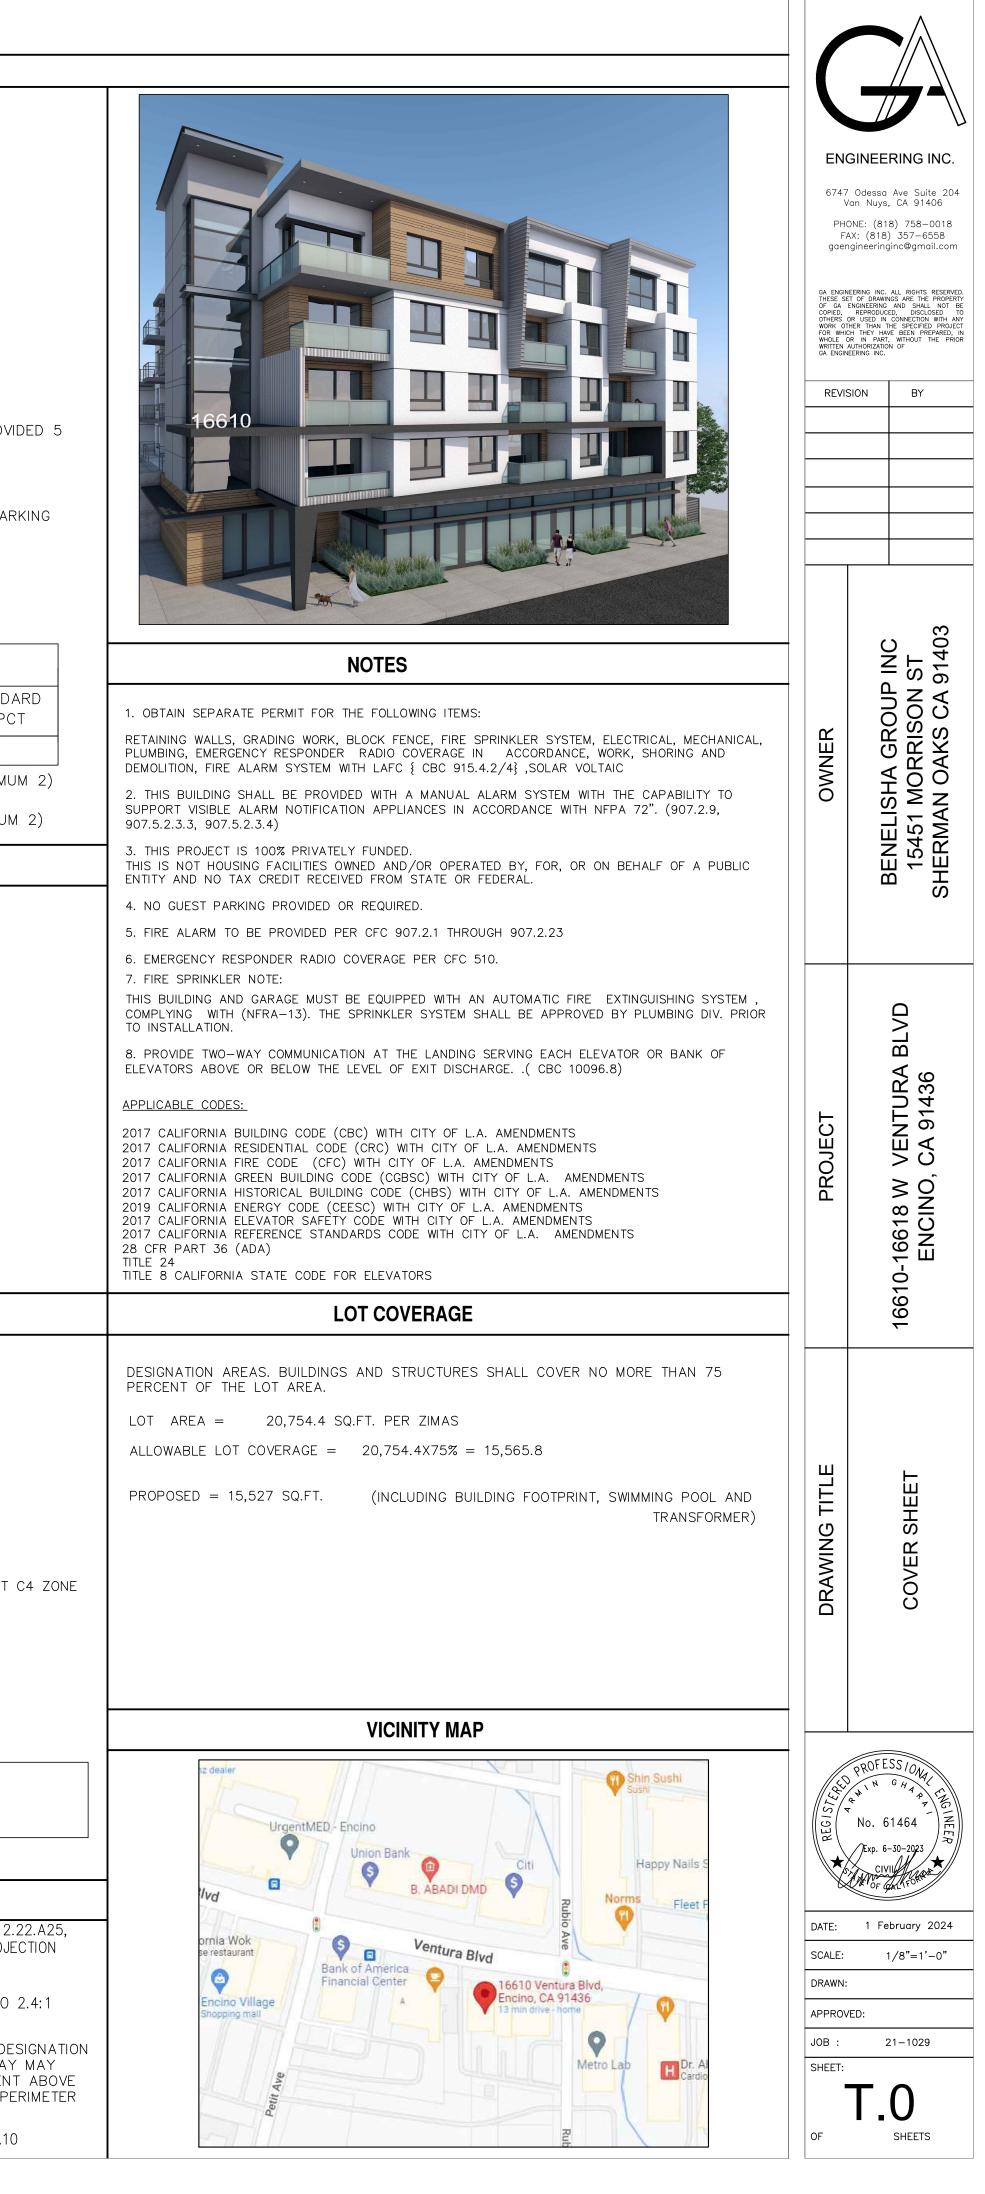


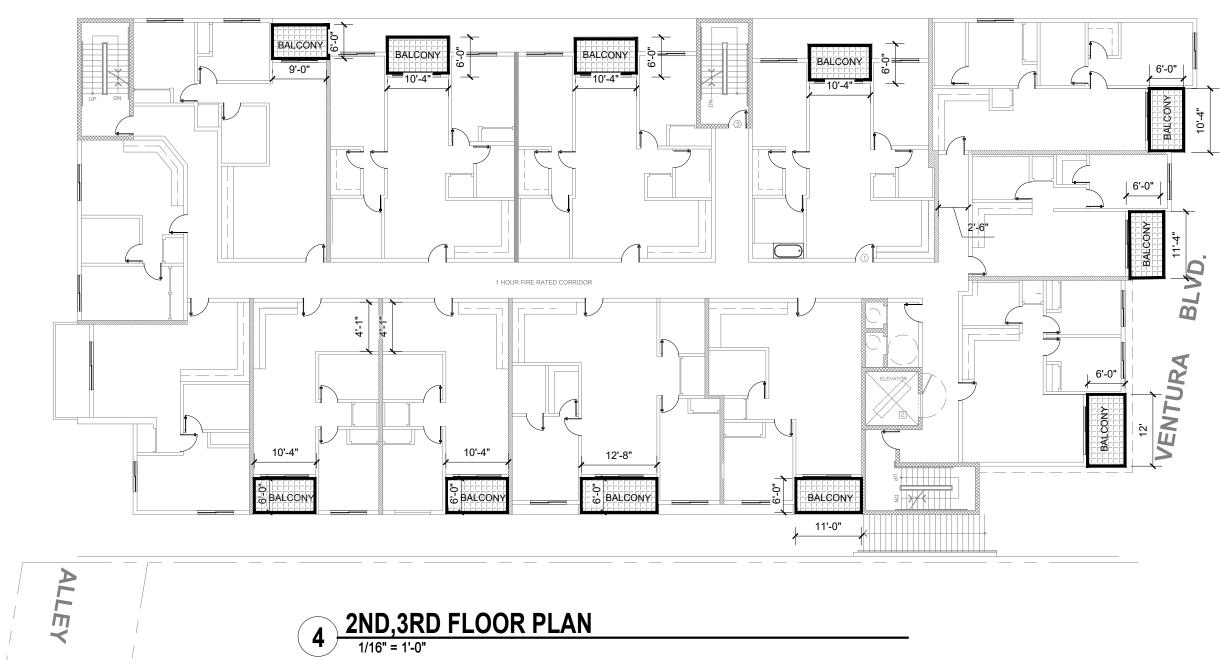

OPEN SPACE= 11 X50 =550 SQ.FT 550 X2 =1,100 SQ.FT

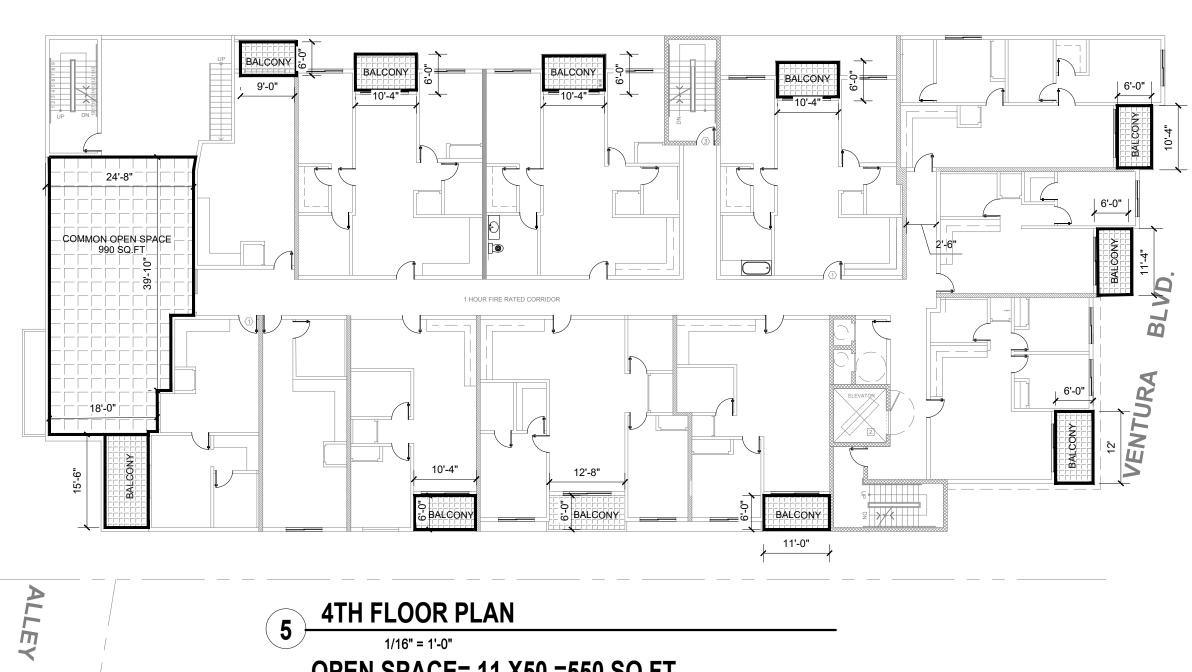

OPEN SPACE= 11 X50 =550 SQ.FT

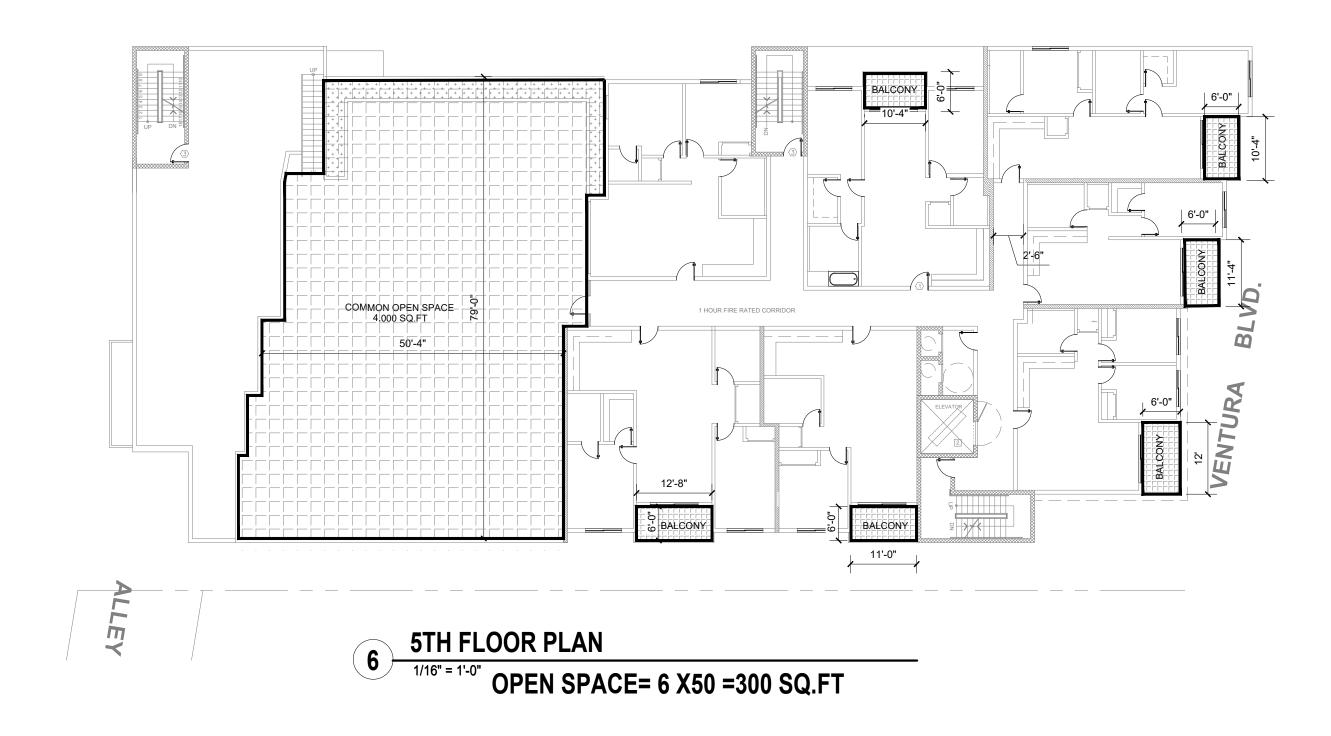


REQUIRED


NO. OF BEDROOMS	HABITABLE ROOMS	QUANTITY OF UNITS	OPEN SPACE
STUDIO	2	4	4 X 100 = 400
1	2	17	$17X \ 100 = 1,700$
2	3	24	24X 125 = 3,000
TOTAL REQUIRED			5,100 SQ.FT

PROVIDED

AREA DESCRIPTION	OPEN SPACE
DECK @ 5TH FLOOR	4,000 SQ.FT.
DECK @ 4TH FLOOR	990 SQ.FT.
BALCONY 28X50	1,400 SQ.FT.
TOTAL PROVIDED	6,390 SQ.FT.


Odessa an Nuys, DNE: (81 X: (818) gineering	RING INC. Ave Suite 204 CA 91406 8) 758–0018 357–6558 inc@gmail.com ALL RIGHTS RESERVED. IGS ARE THE PROPERTY AND SHALL NOT BE ED. DISCISSED TO CONNECTION WITH ANY HE SPECIFIC PROPERTY AND SHALL NOT BE ED. DISCISSED TO CONNECTION WITH ANY HE SPECIFIC PROPERTY NOF
BENELISHA GROUP INC	15451 MORRISON ST SHERMAN OAKS CA 91403
	16610 VEN I UKA BLVD ENCINO, CA 91436
	OPEN SPACE DIAGRAM
Exp. 6-	-30-2023
	ebruary 2024 /16"=1'-0"
ED:	
2	21—1029
۲ſ	I.5 SHEETS

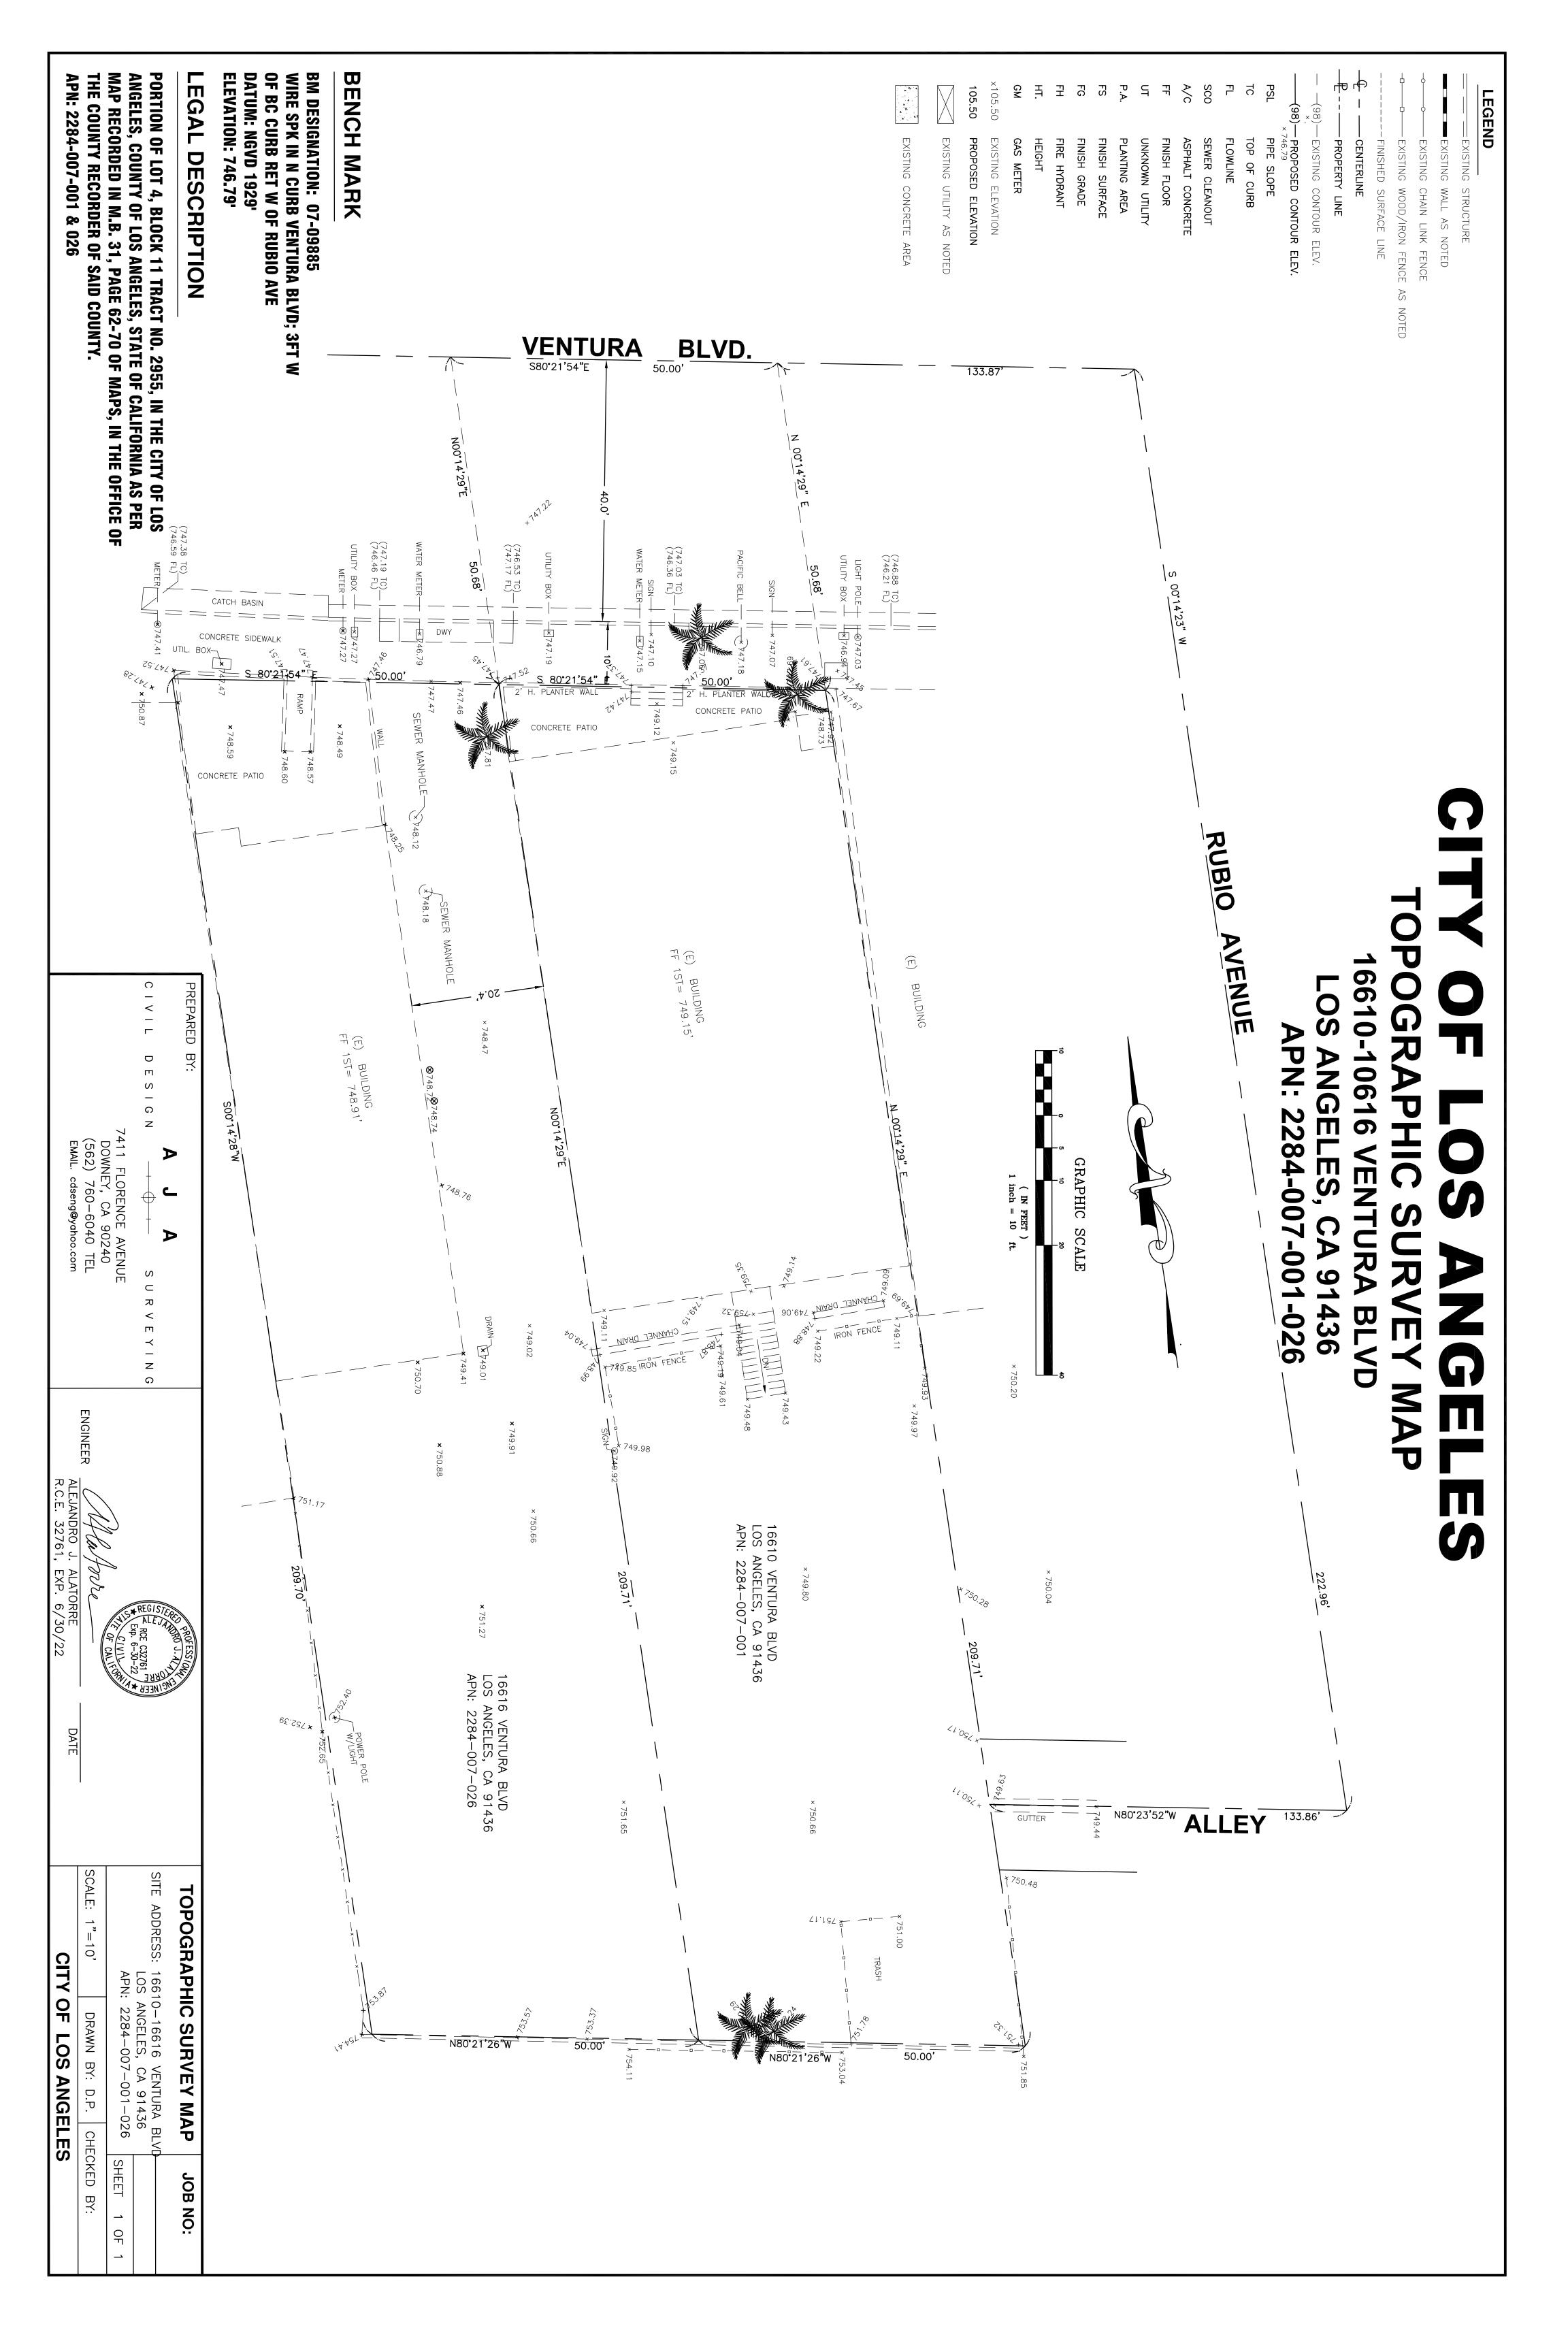


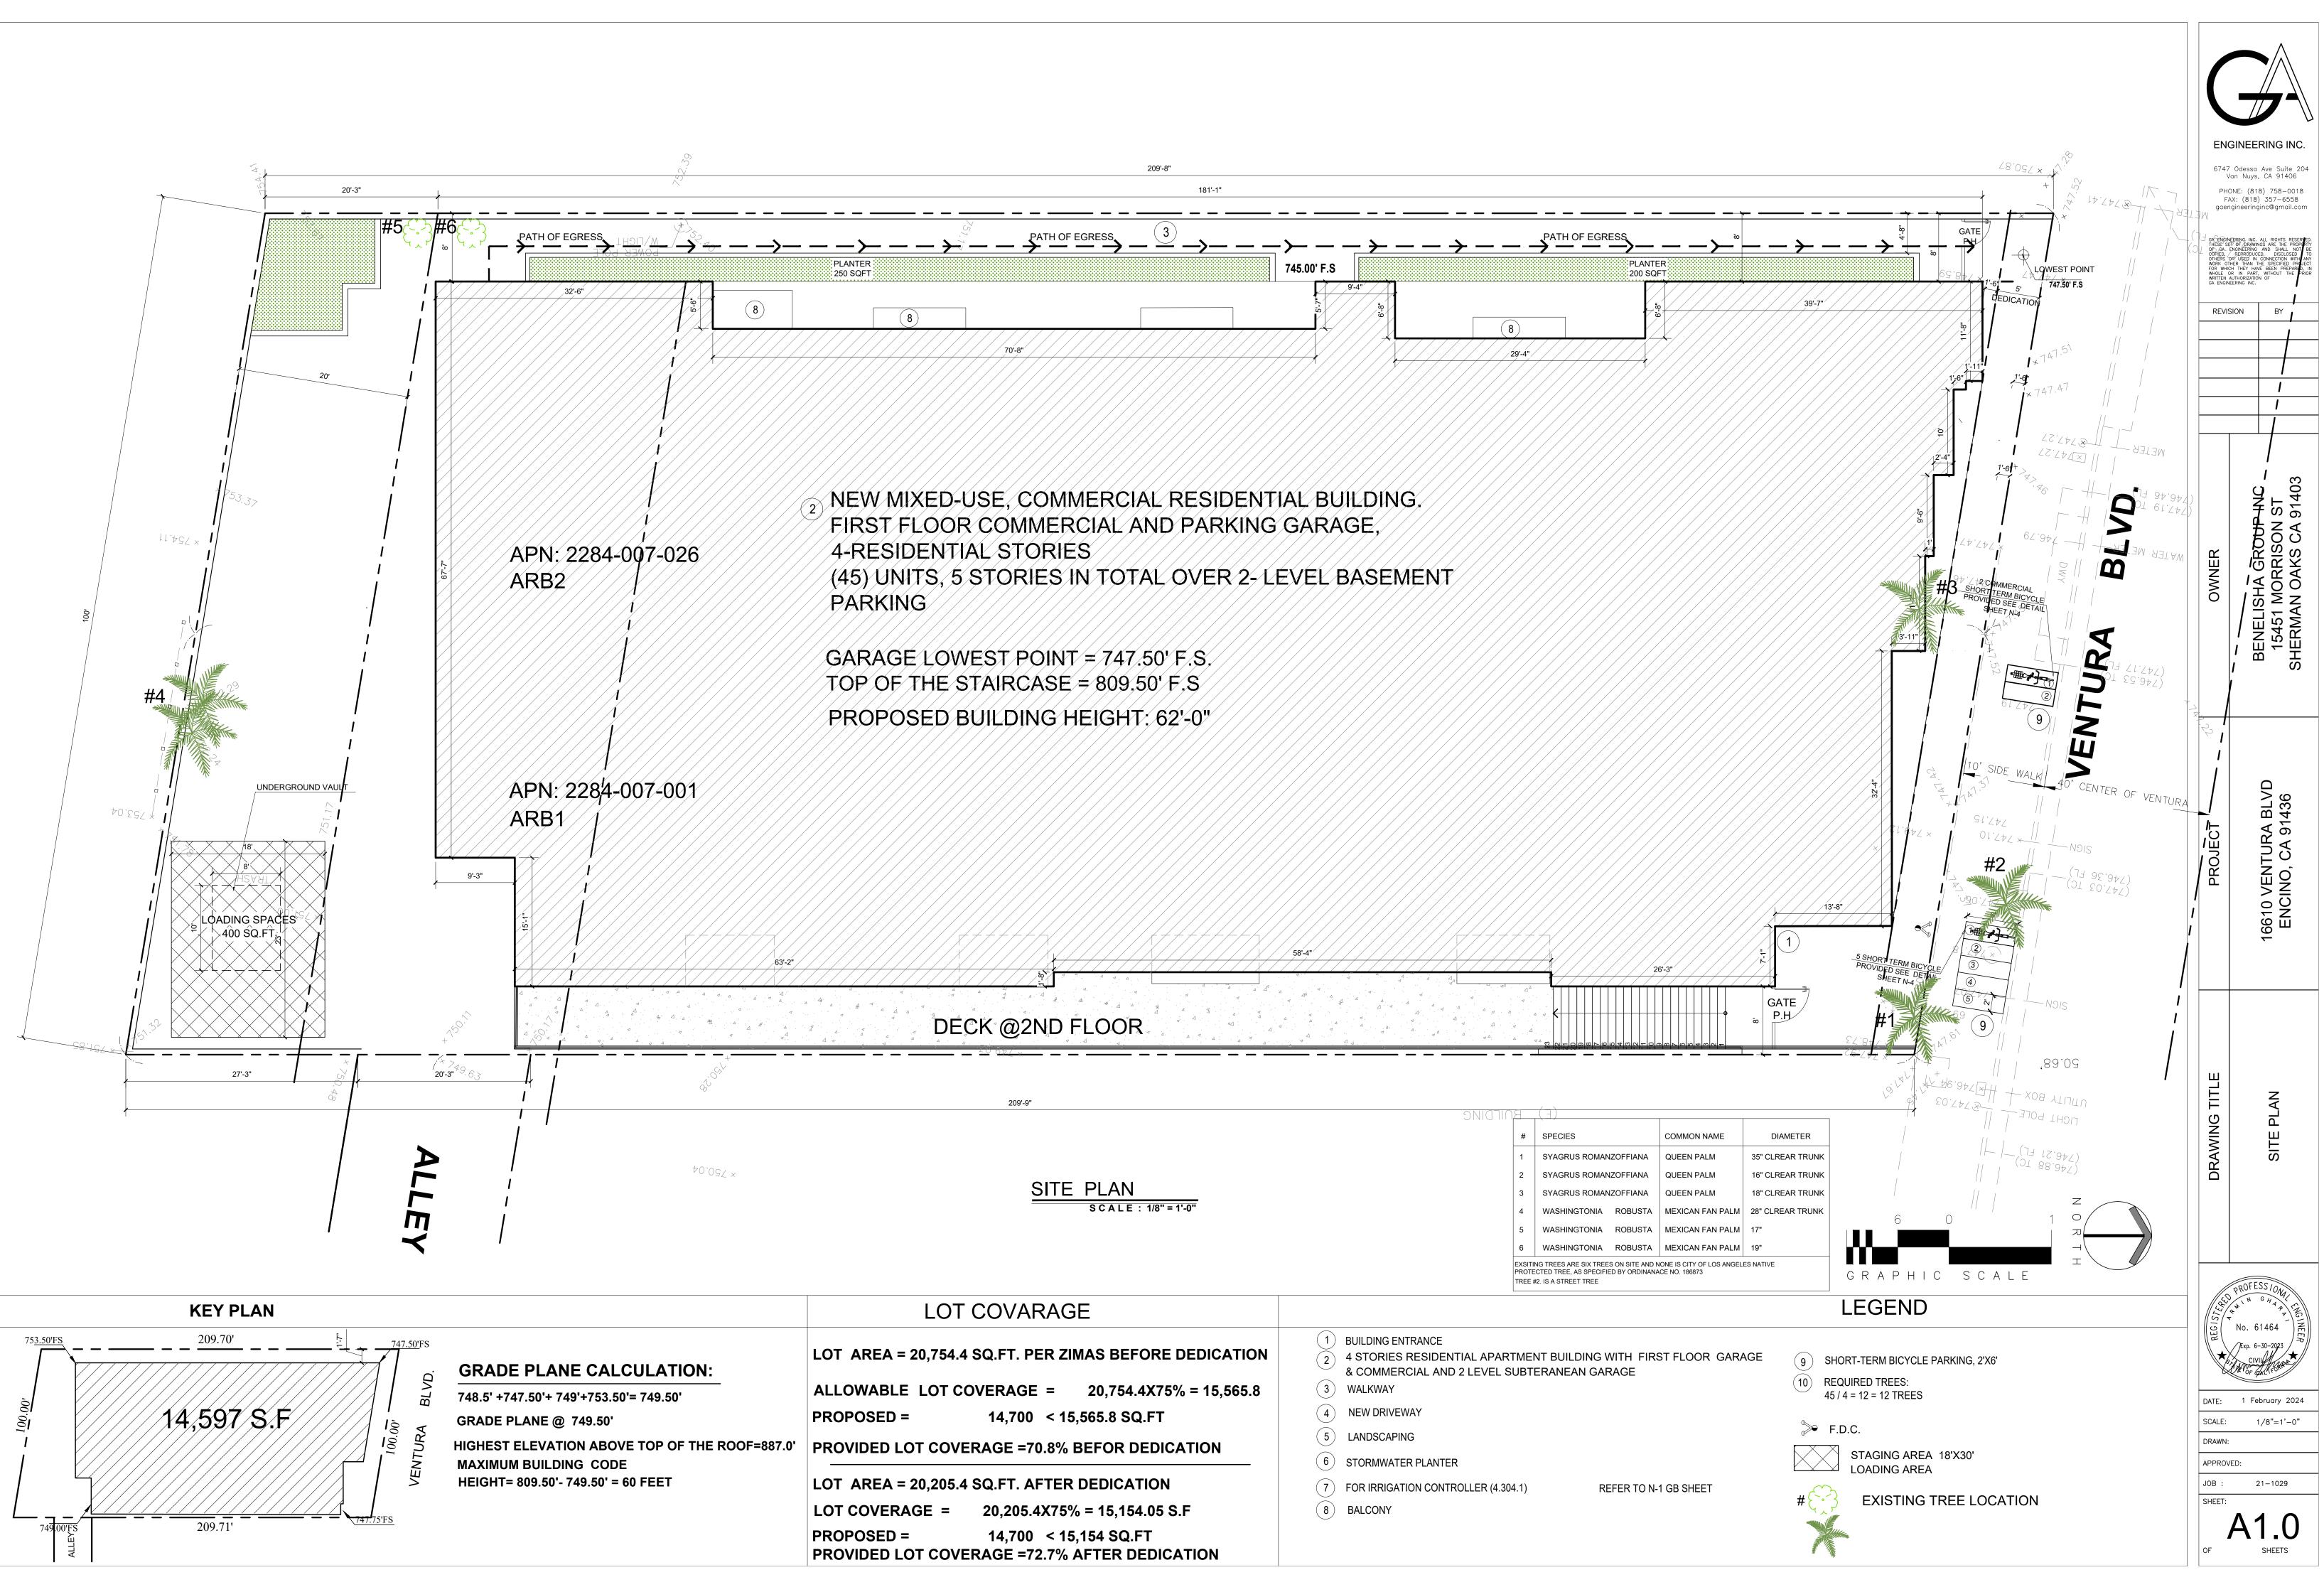



			209'-8"		
			181'-1"		
	PLANTER 250 SQFT	<u> </u>		745.00' F.S	PL 20
	8			20	
7 + 		70'-8"			(8)

209'-9"	
SITE PLAN scale: 1/8" = 1'-0"	9 NIGTINE (1) # SPECIES 1 SYAGRUS ROMANZOFFIAN 2 SYAGRUS ROMANZOFFIAN 3 SYAGRUS ROMANZOFFIAN 4 WASHINGTONIA 5 WASHINGTONIA 6 WASHINGTONIA 8 Exsiting TREES ARE SIX TREES ON SITE 9 PROTECTED TREE, AS SPECIFIED BY ORD 10 TREE #2. IS A STREET TREE
LOT COVARAGE	
LOT AREA = 20,754.4 SQ.FT. PER ZIMAS BEFORE DEDICATION ALLOWABLE LOT COVERAGE = 20,754.4X75% = 15,565.8 PROPOSED = 14,700 < 15,565.8 SQ.FT .0' PROVIDED LOT COVERAGE =70.8% BEFOR DEDICATION LOT AREA = 20,205.4 SQ.FT. AFTER DEDICATION LOT COVERAGE = 20,205.4X75% = 15,154.05 S.F PROPOSED = 14,700 < 15,154 SQ.FT	 BUILDING ENTRANCE 4 STORIES RESIDENTIAL APARTMENT BUILDING WITH F & COMMERCIAL AND 2 LEVEL SUBTERANEAN GARAGE WALKWAY NEW DRIVEWAY LANDSCAPING STORMWATER PLANTER FOR IRRIGATION CONTROLLER (4.304.1) REFER TO BALCONY

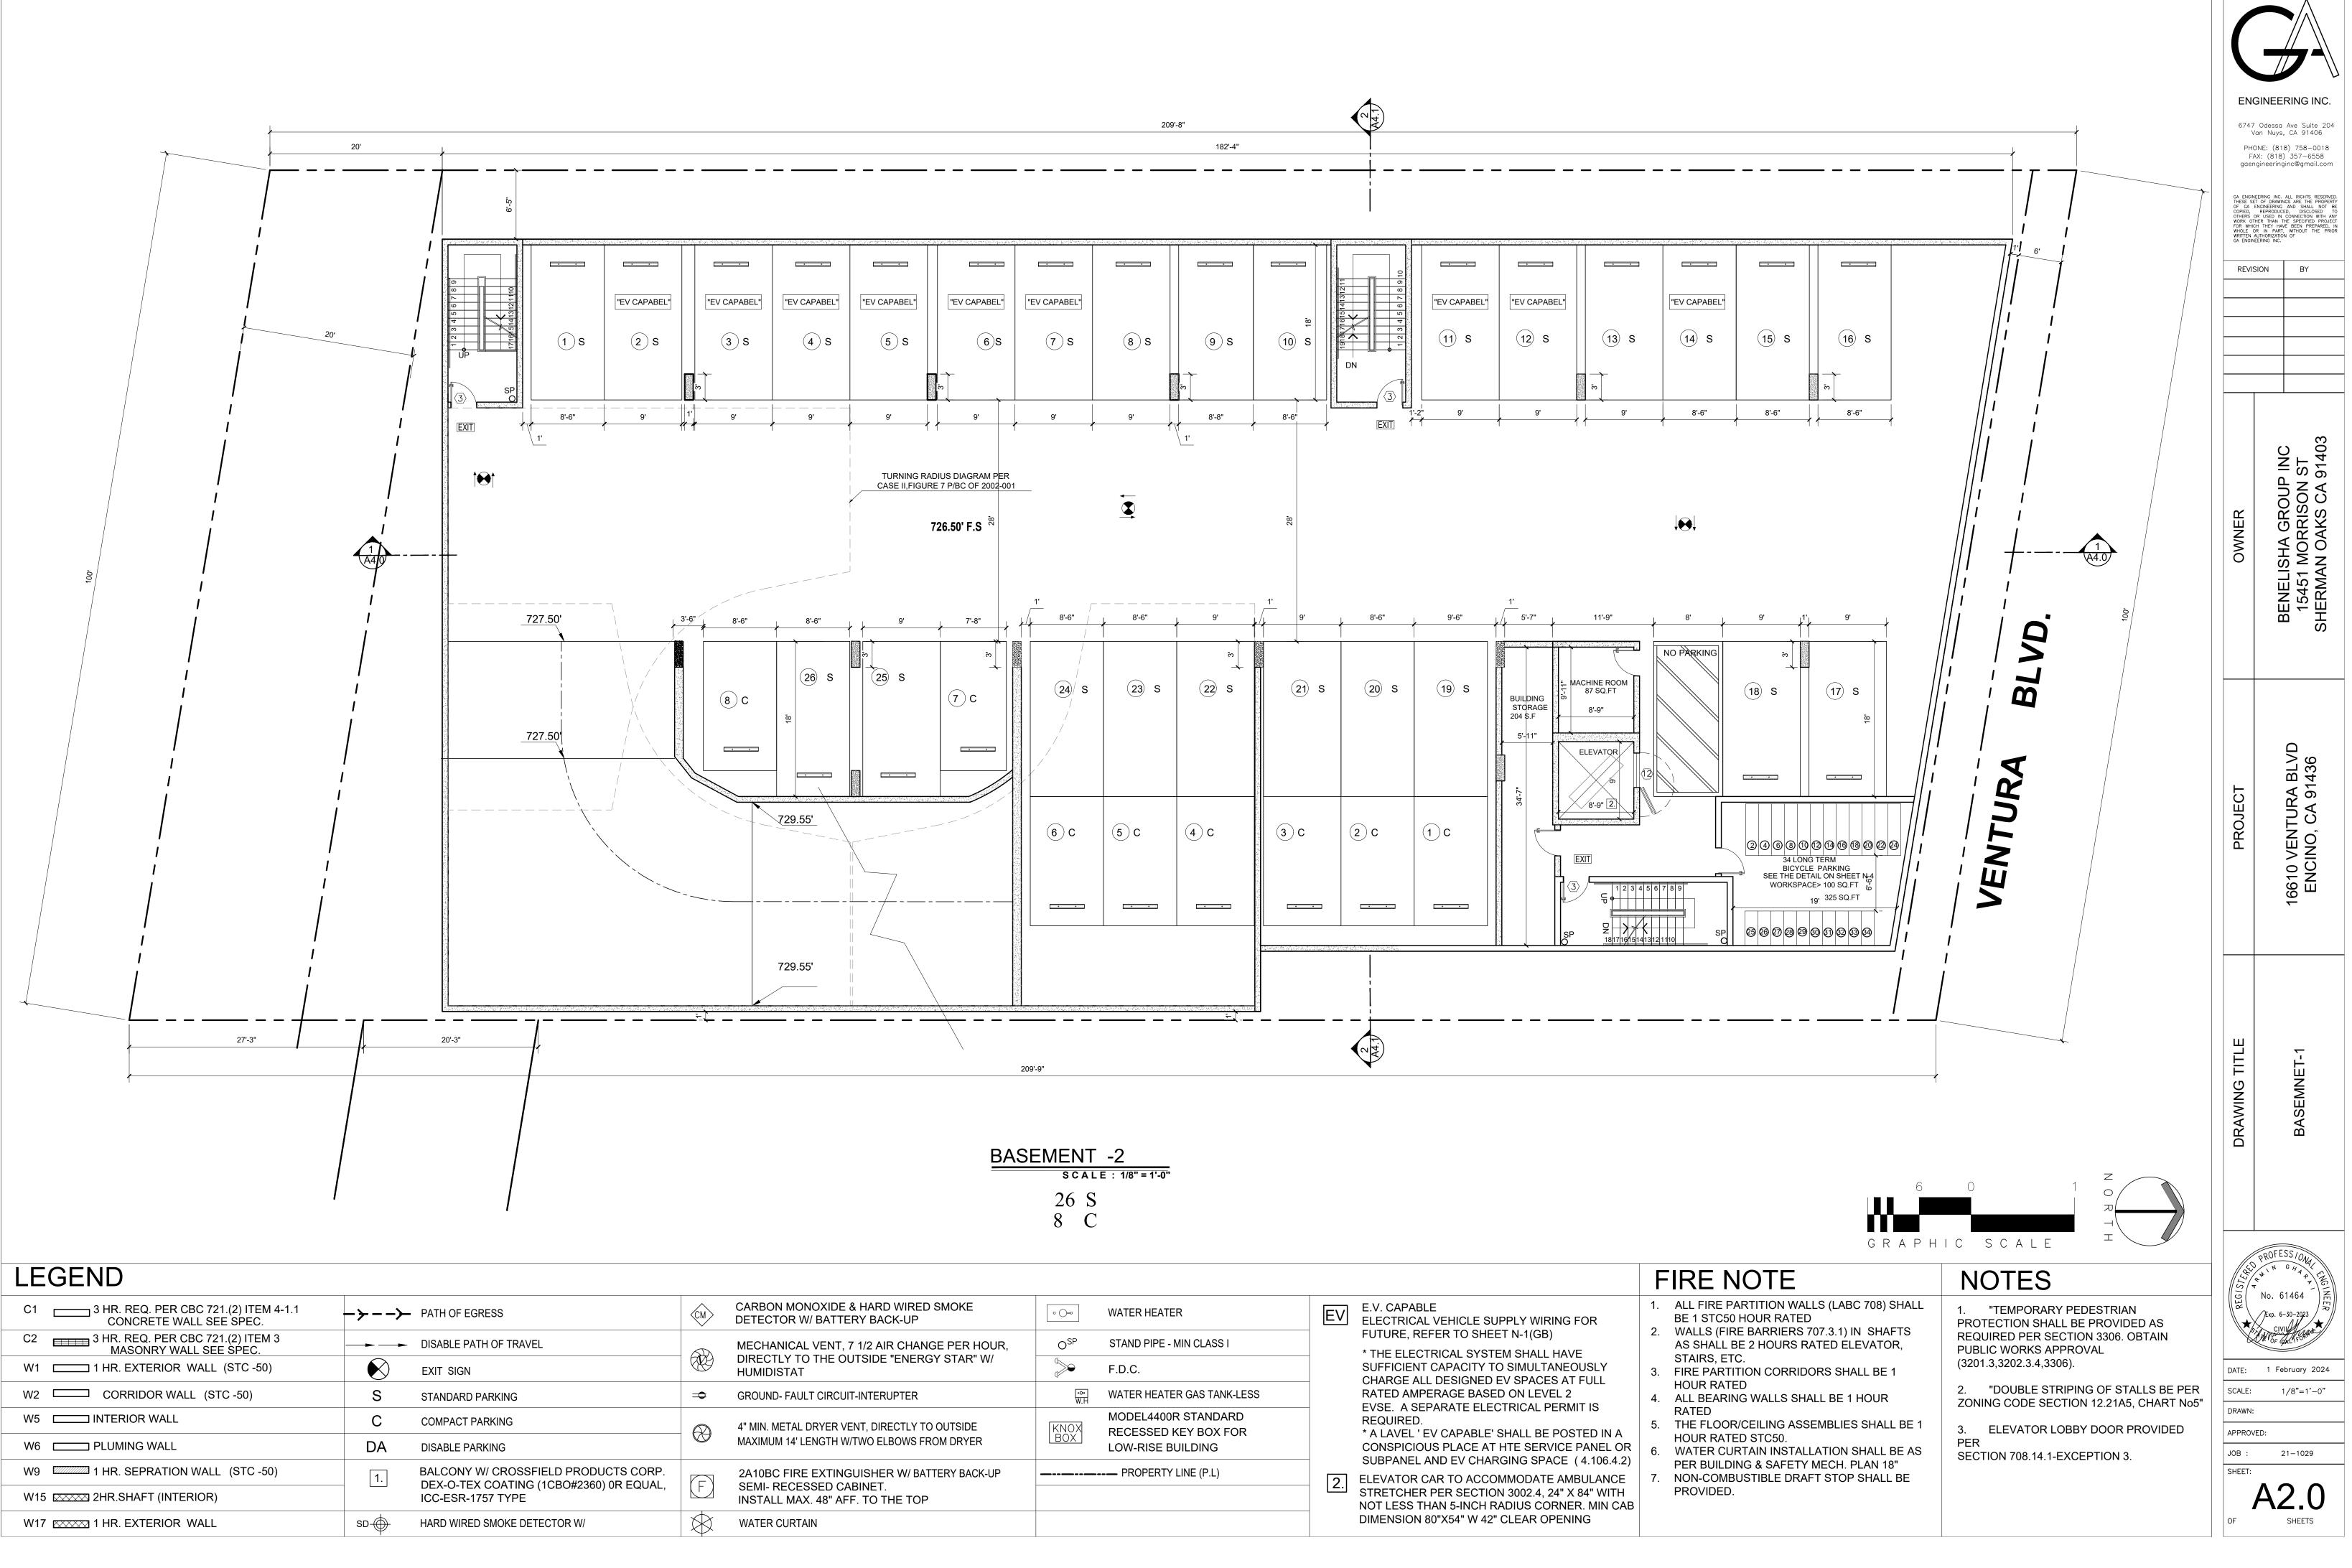

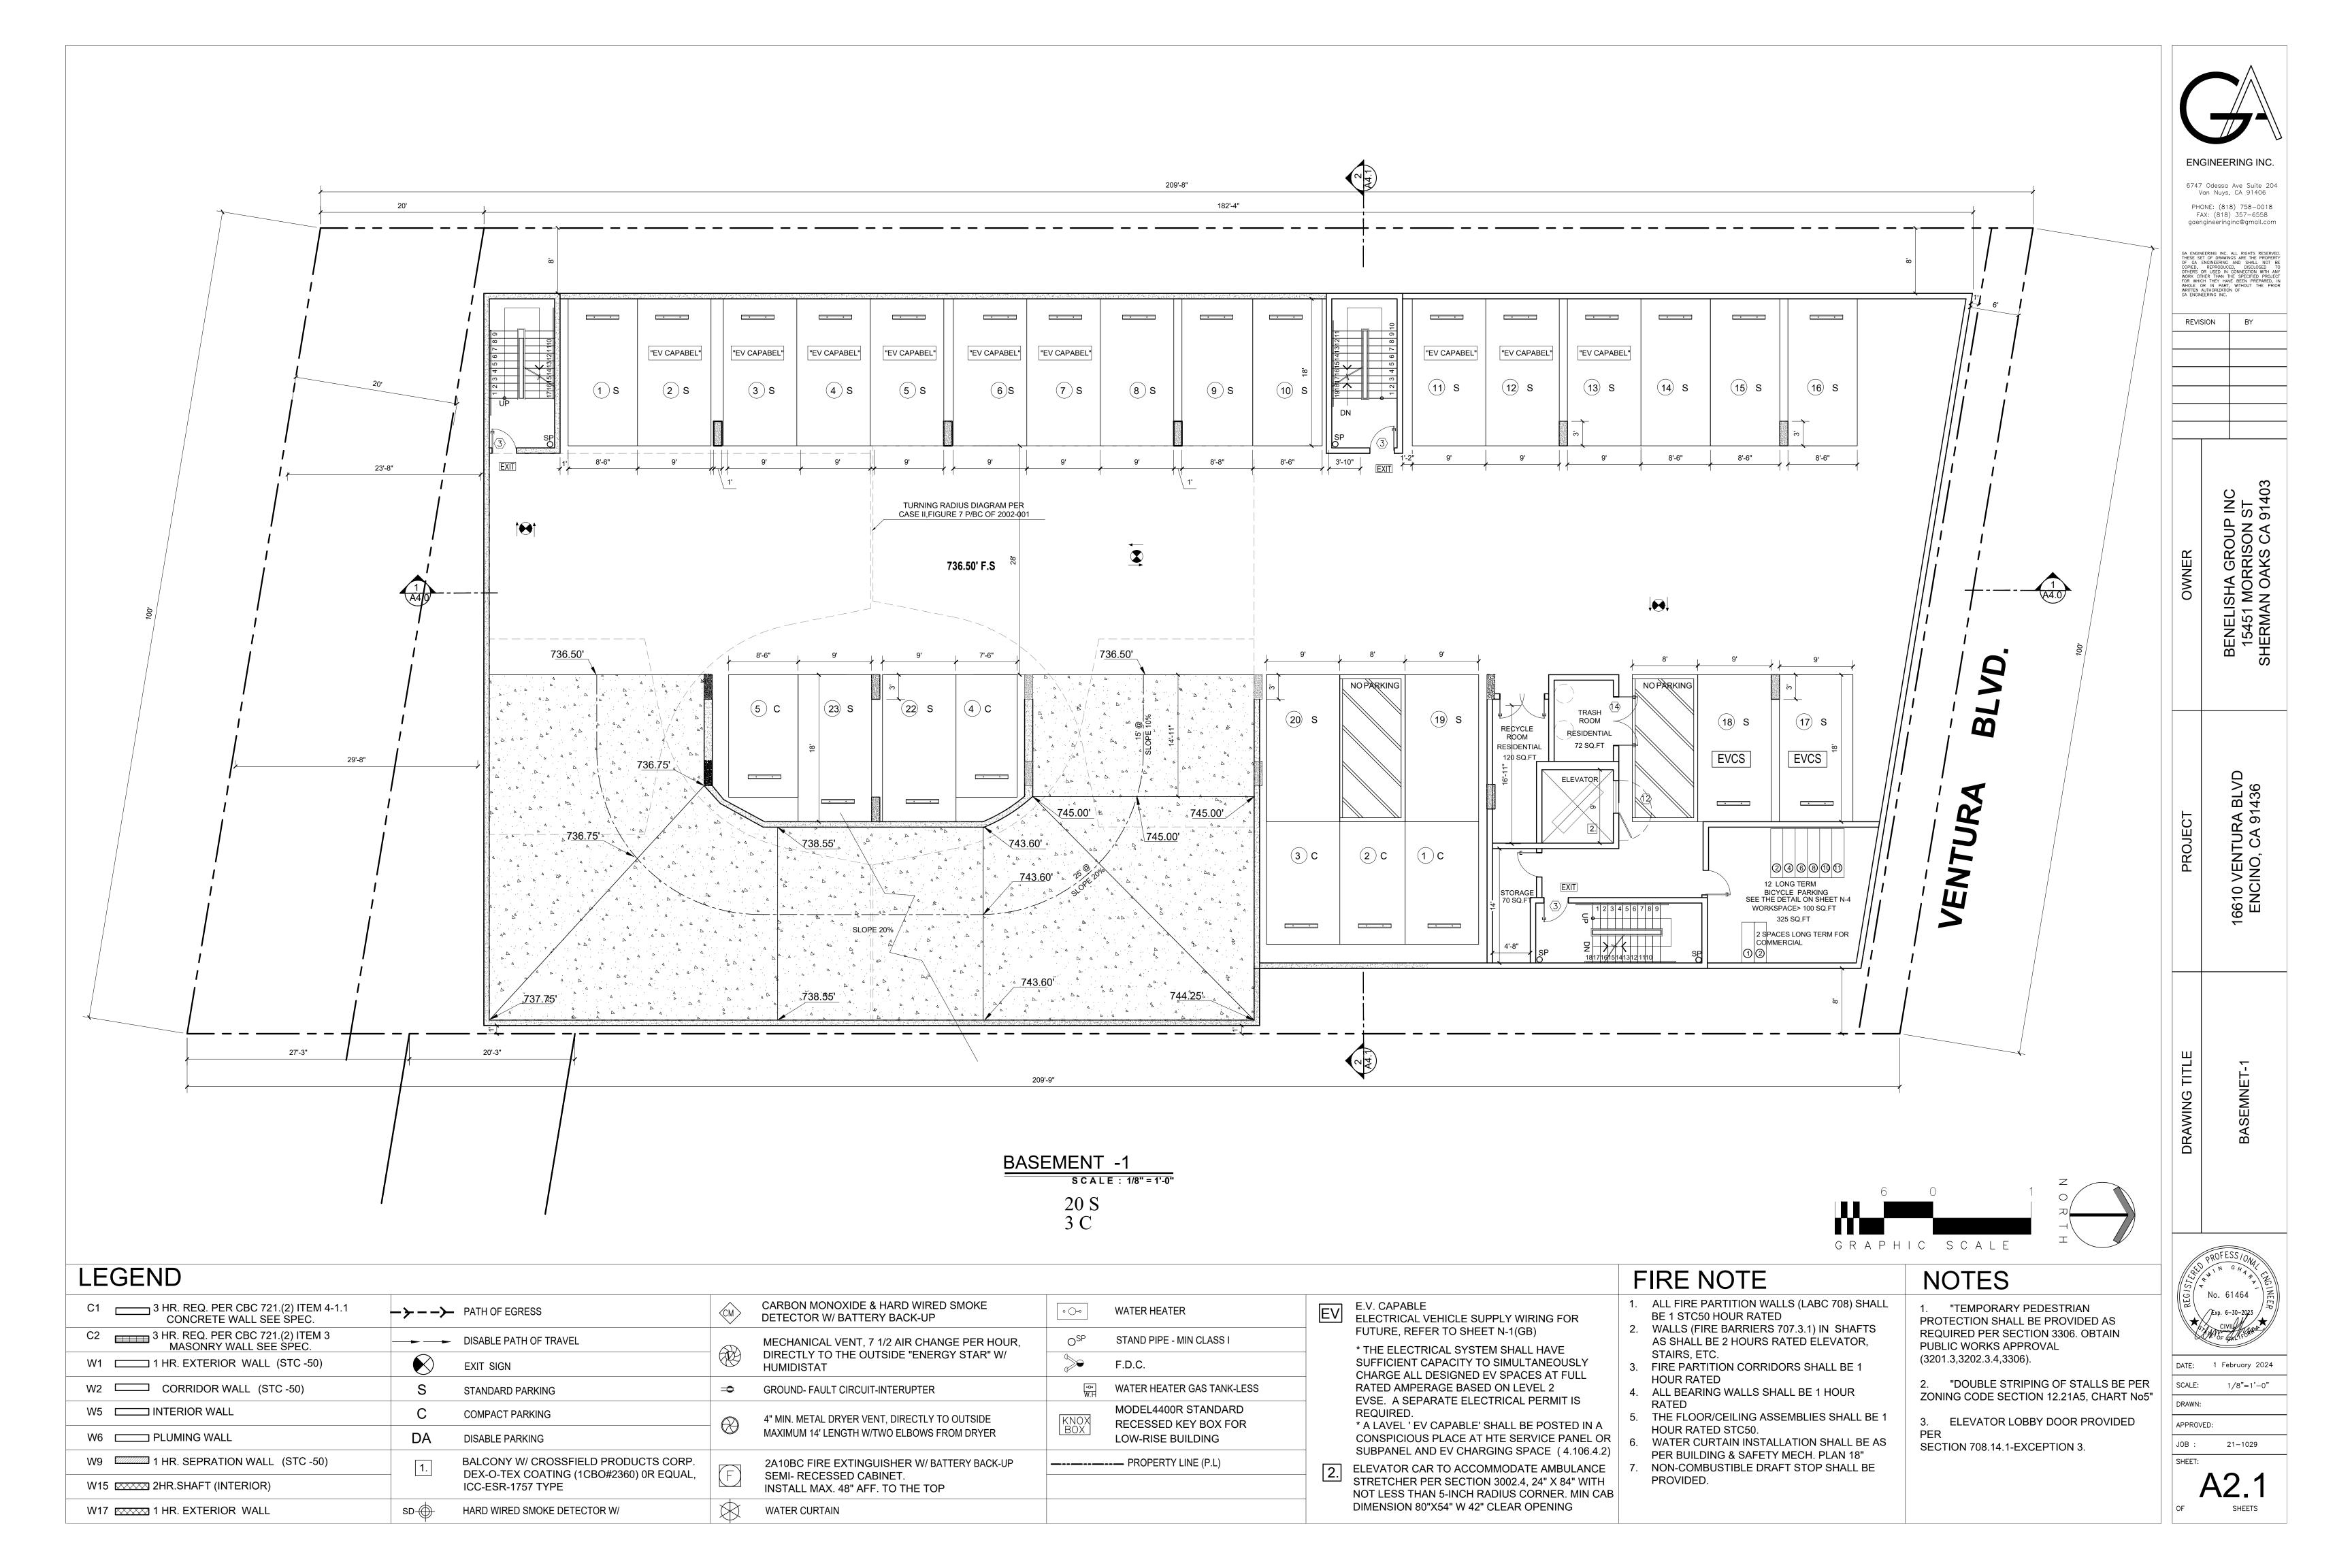

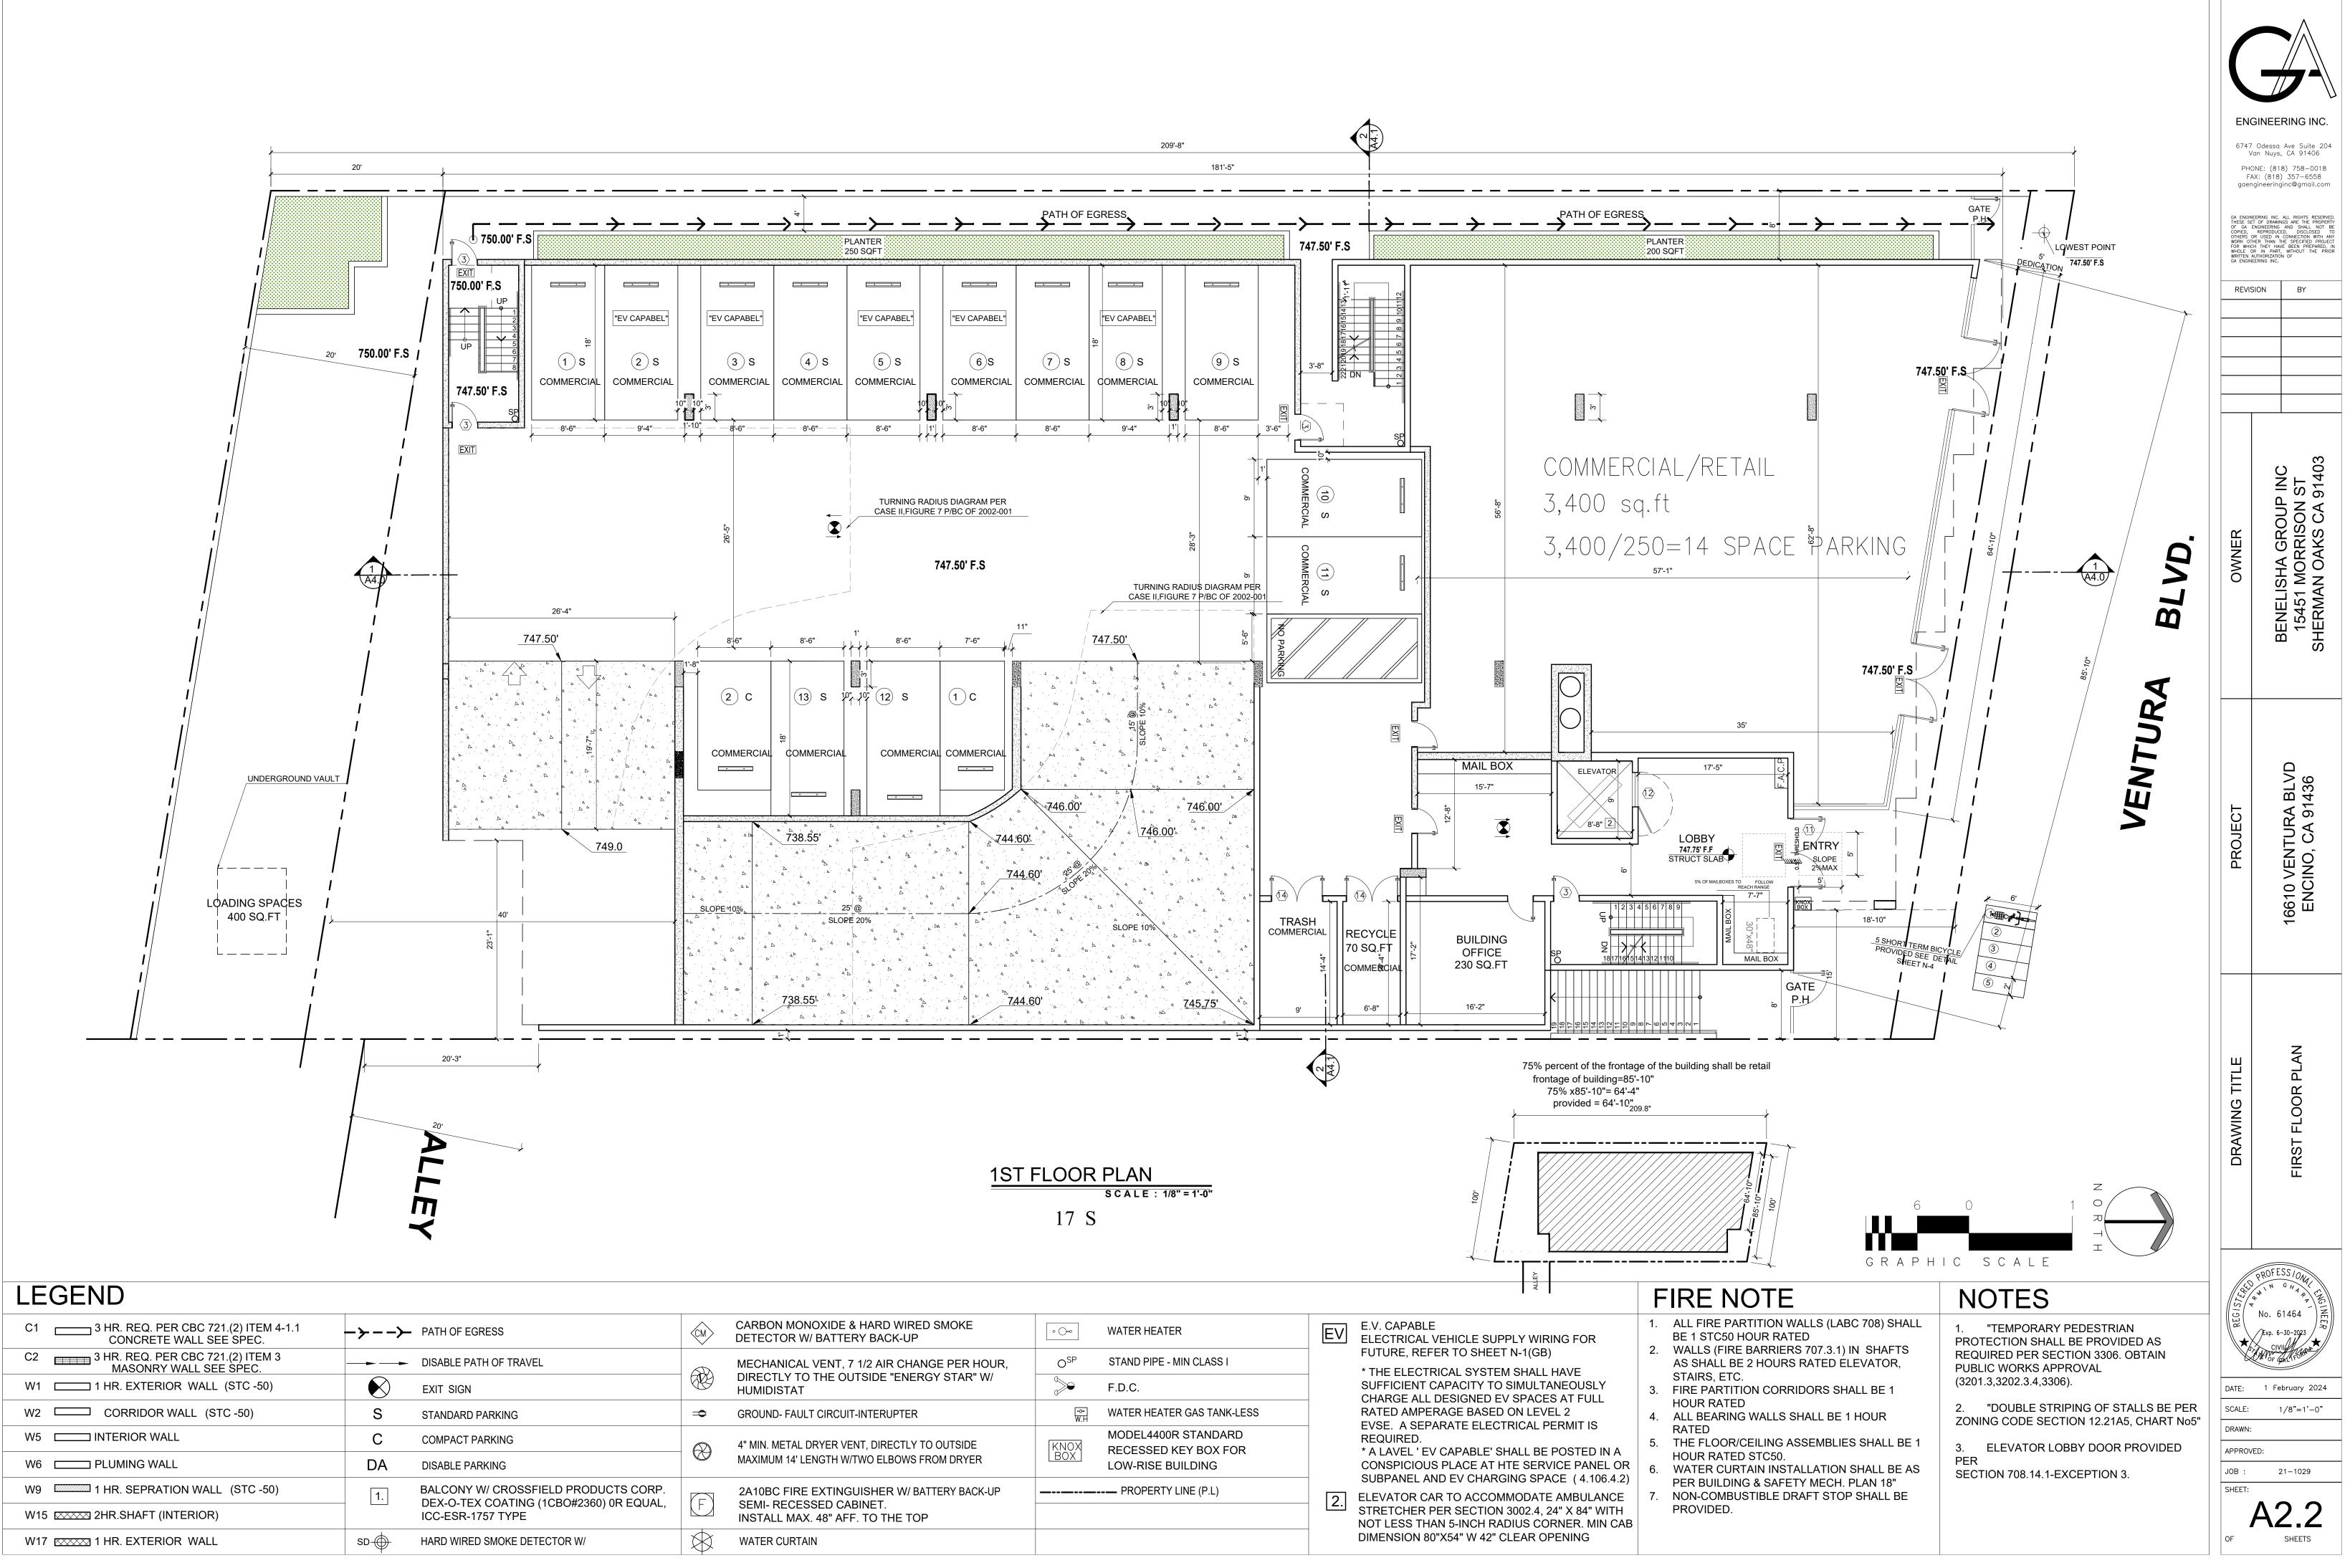

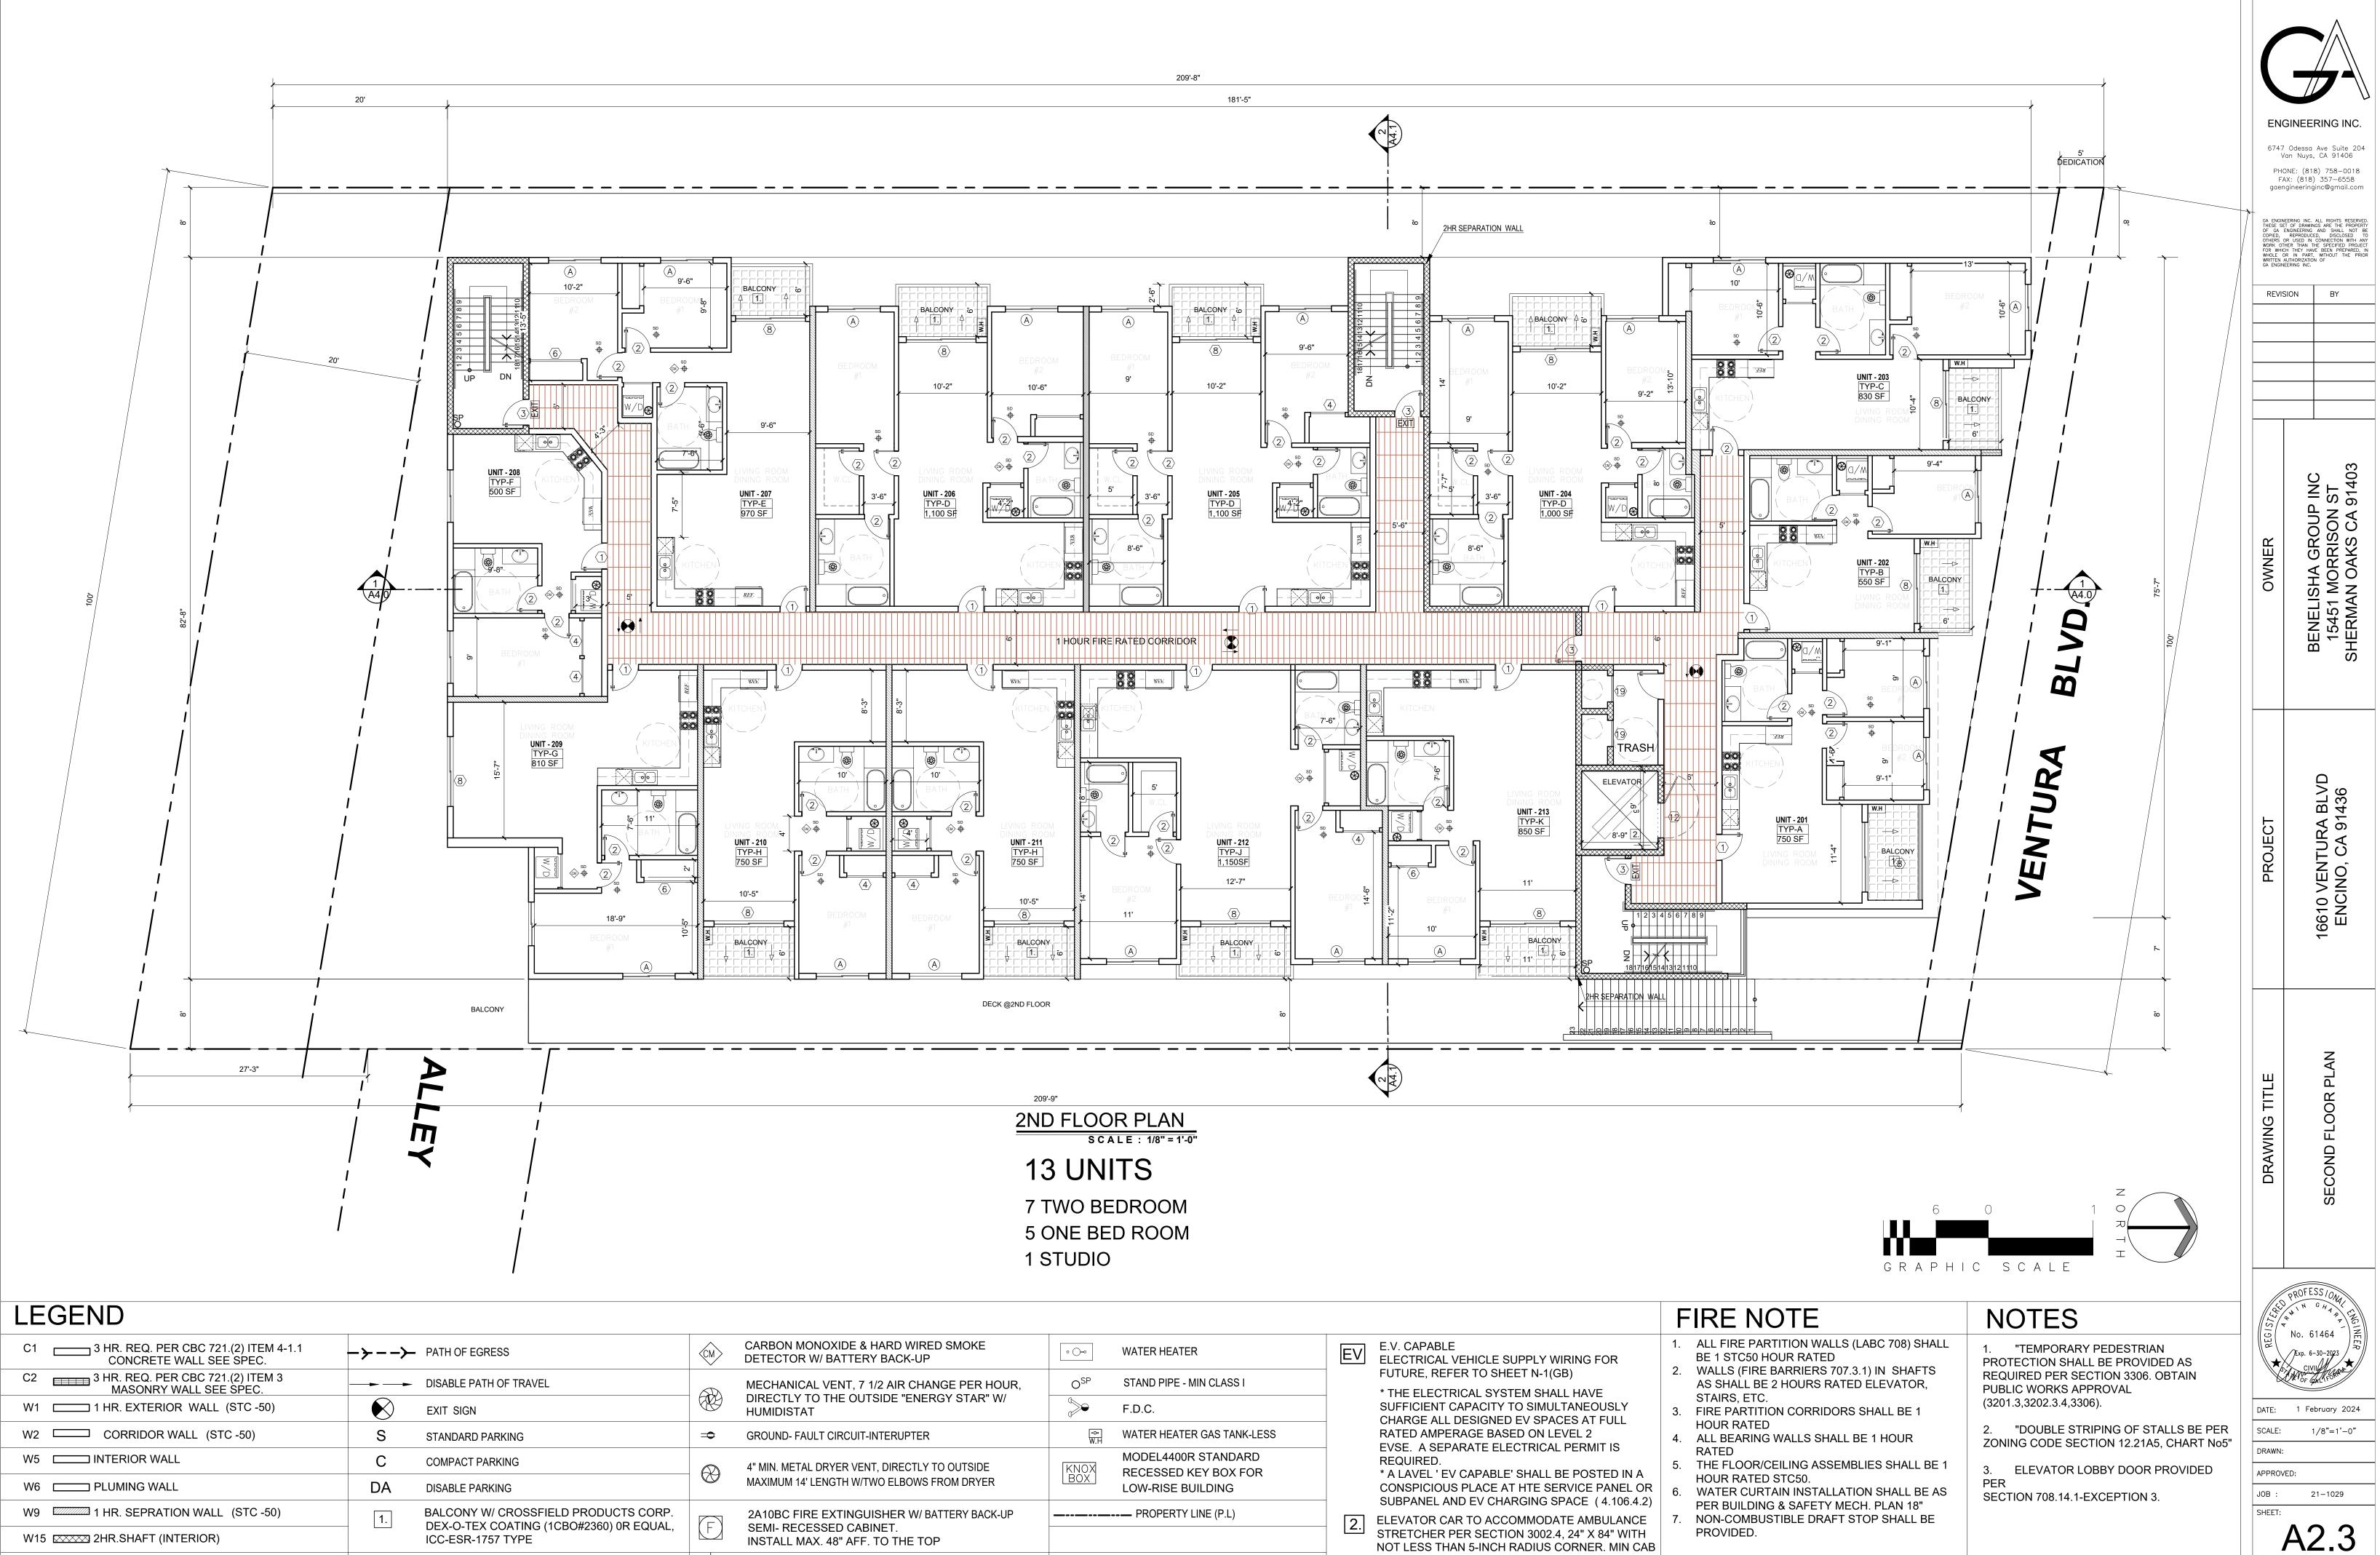

DIMENSION 80"X54" W 42" CLEAR OPENING

SHEETS


W17 XXXXX 1 HR. EXTERIOR WALL


SD-


HARD WIRED SMOKE DETECTOR W/


WATER CURTAIN

 \bigotimes

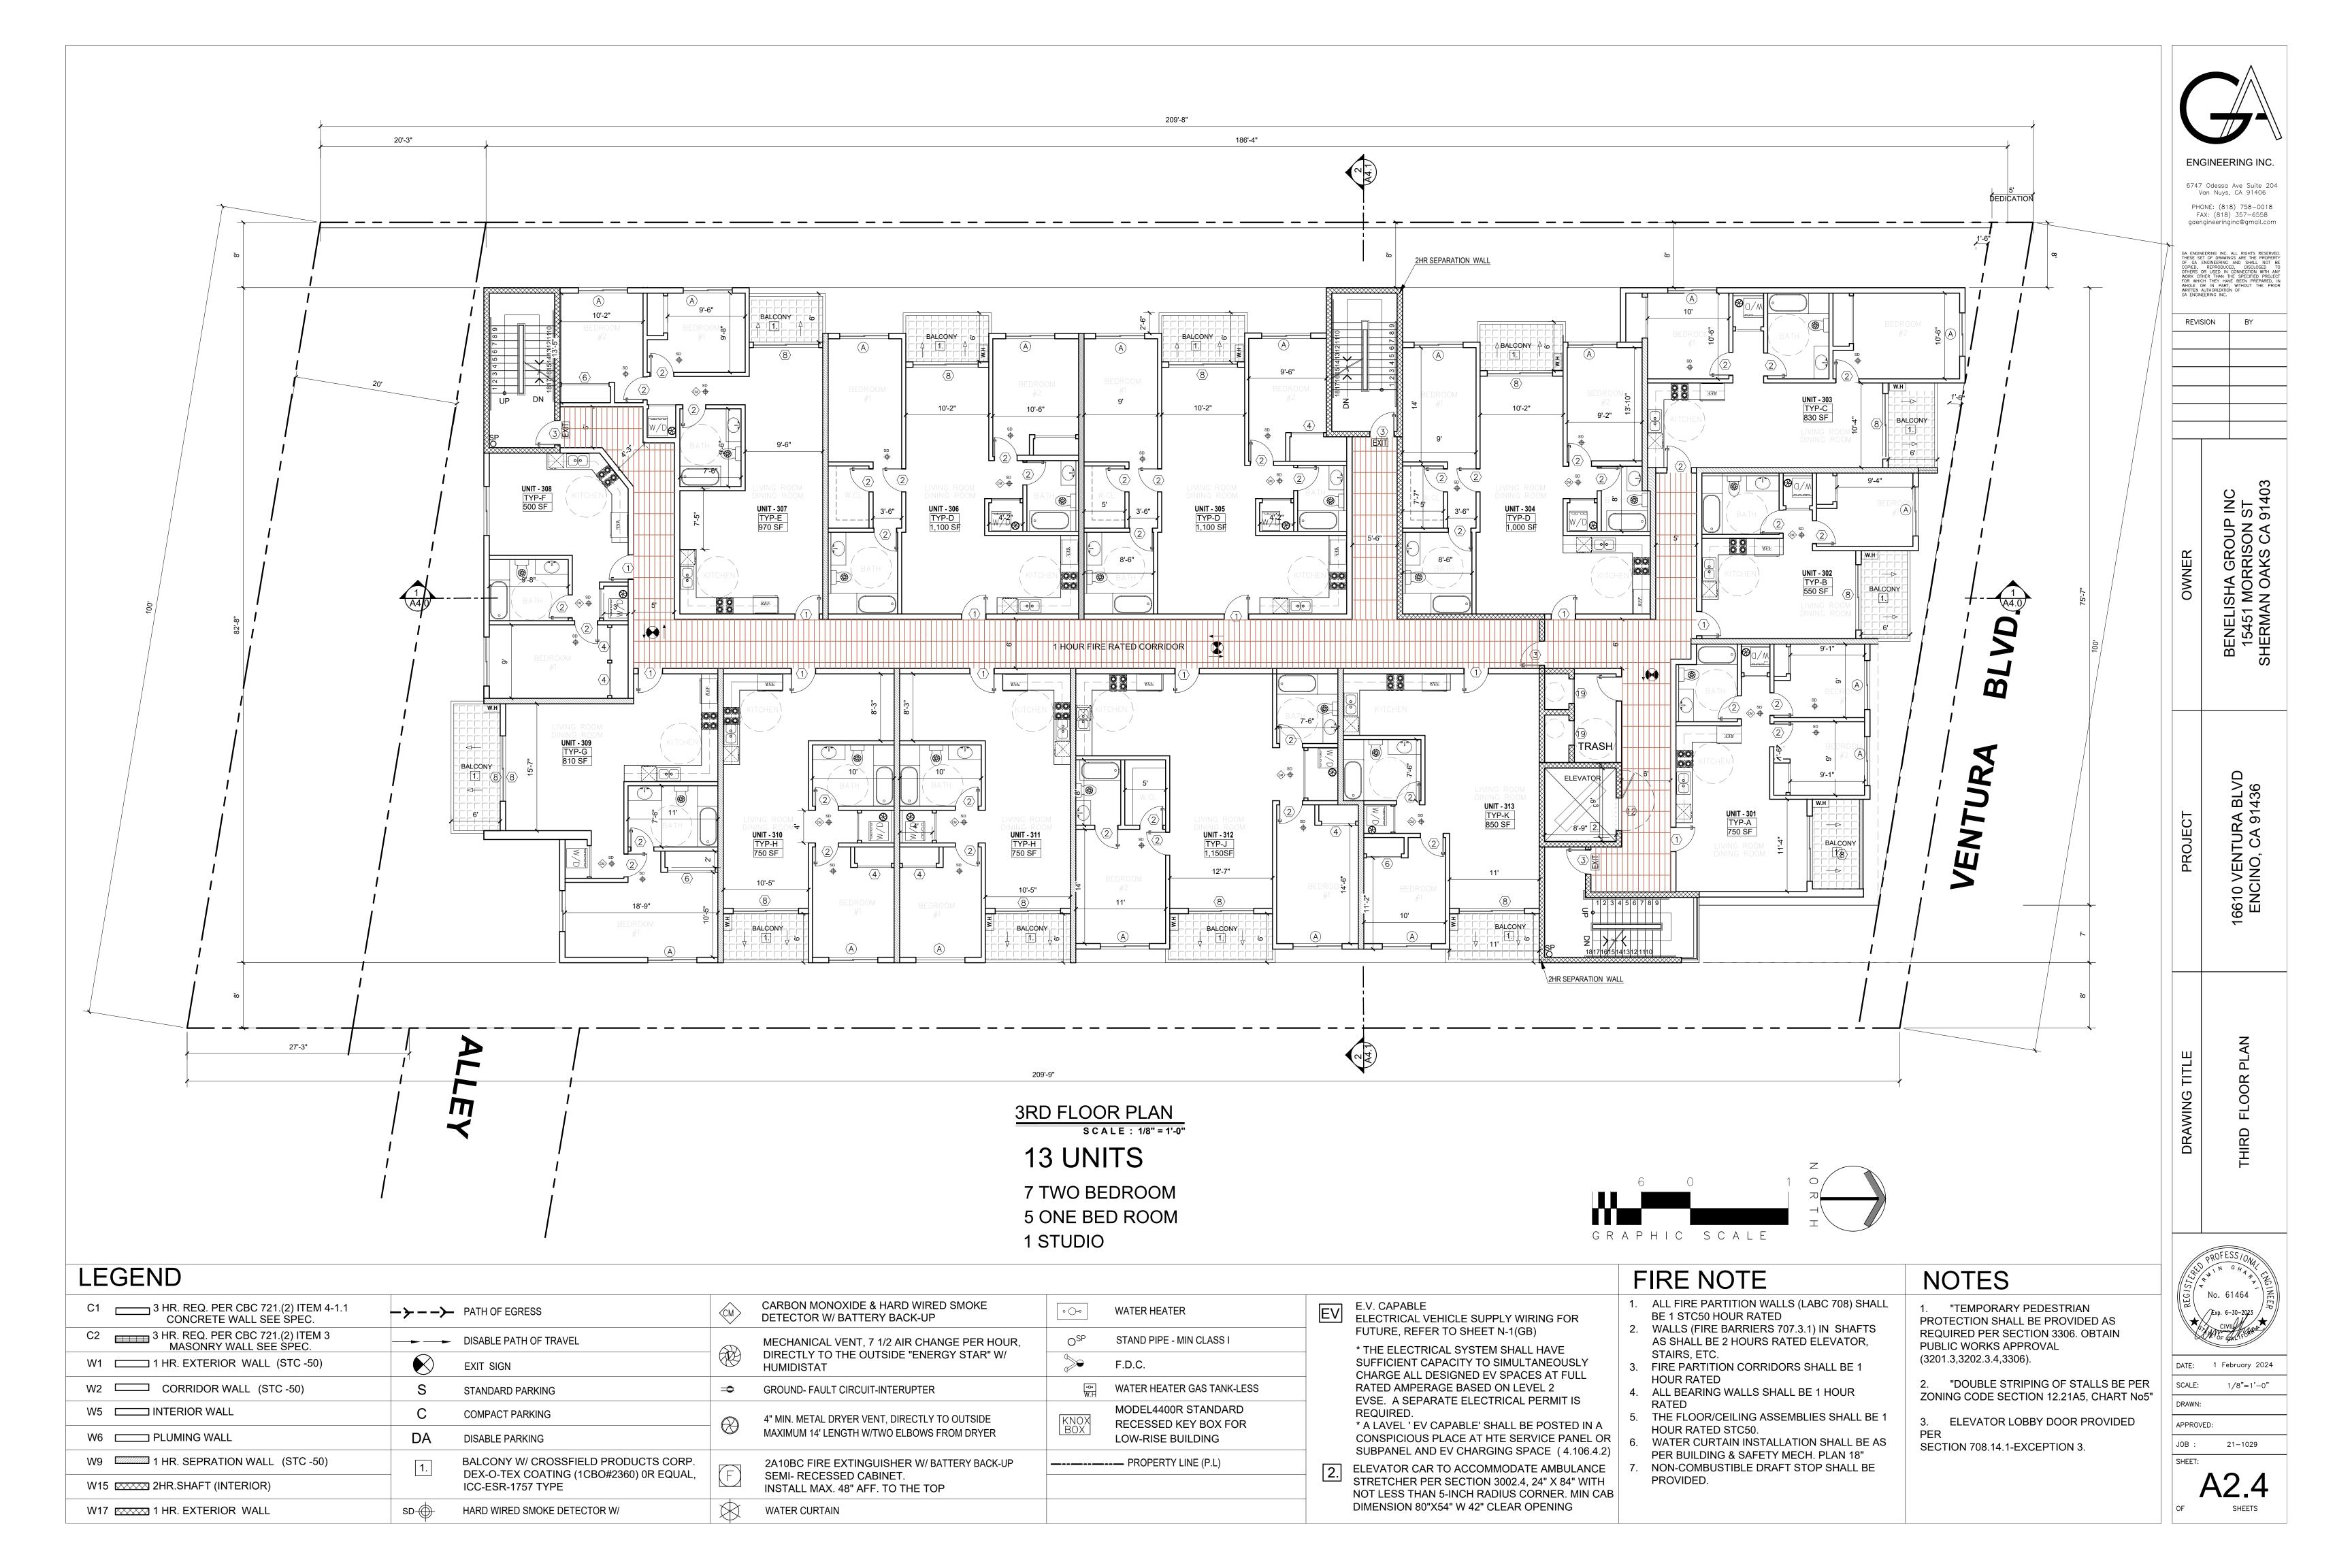


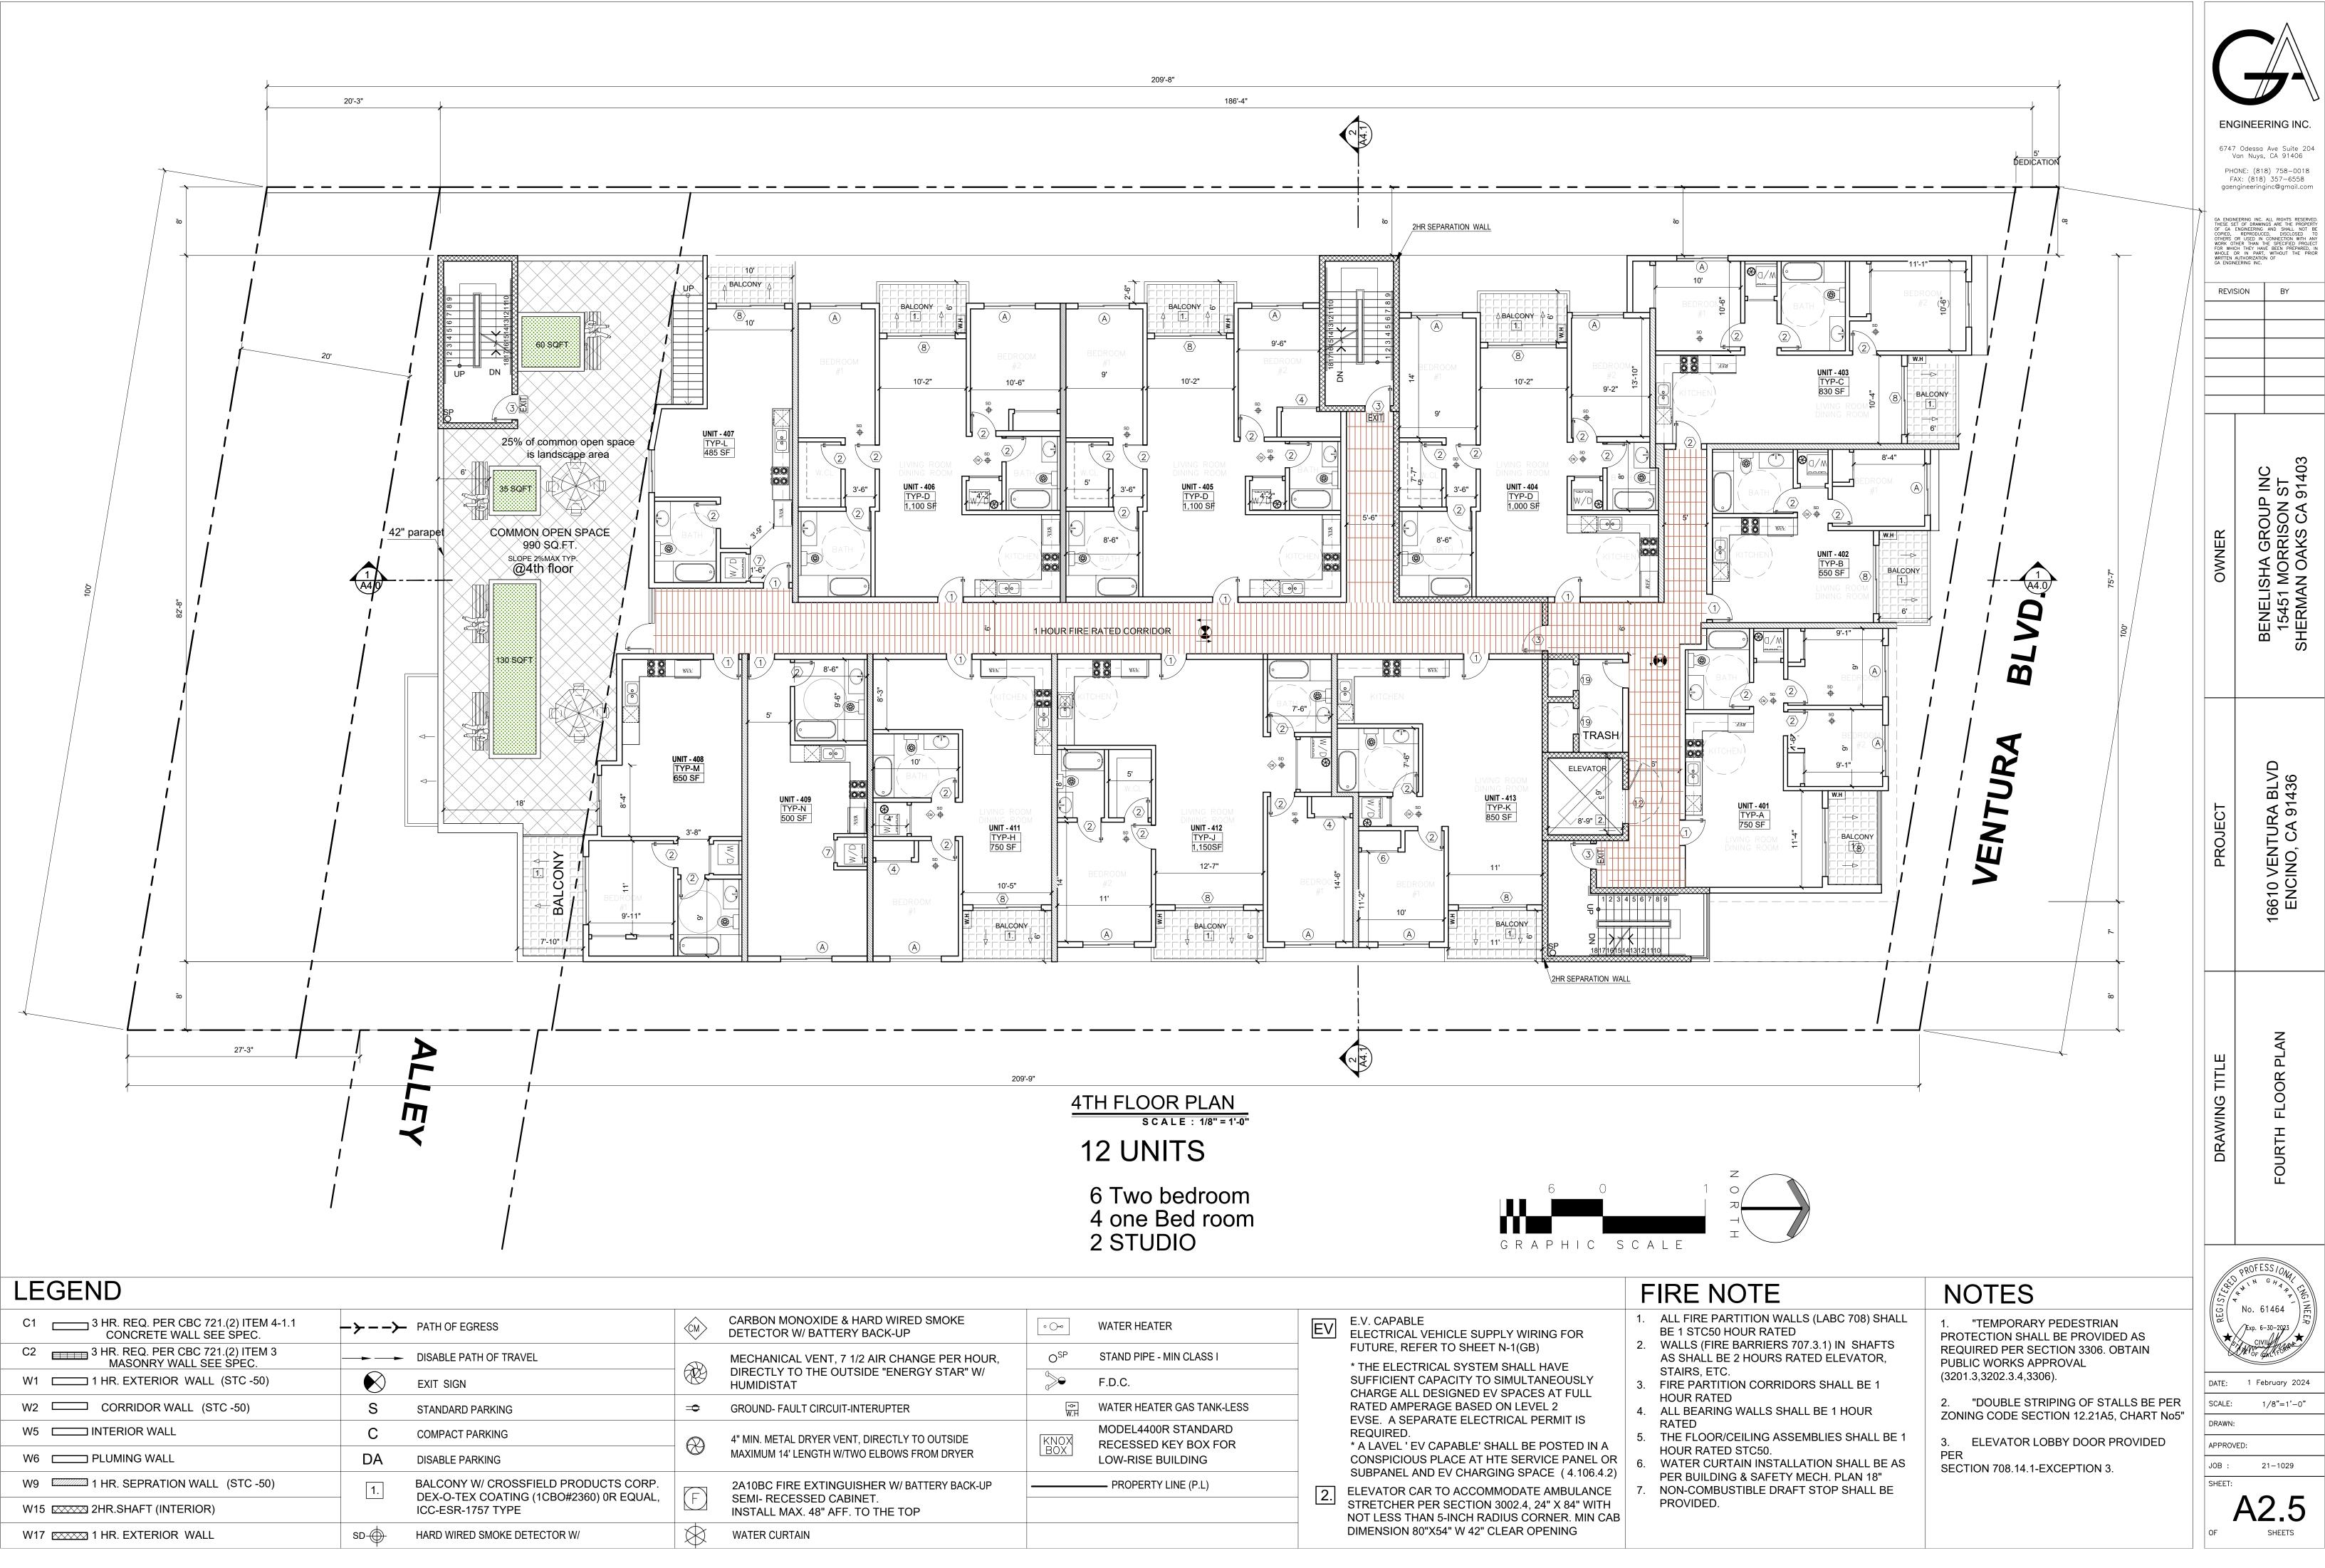

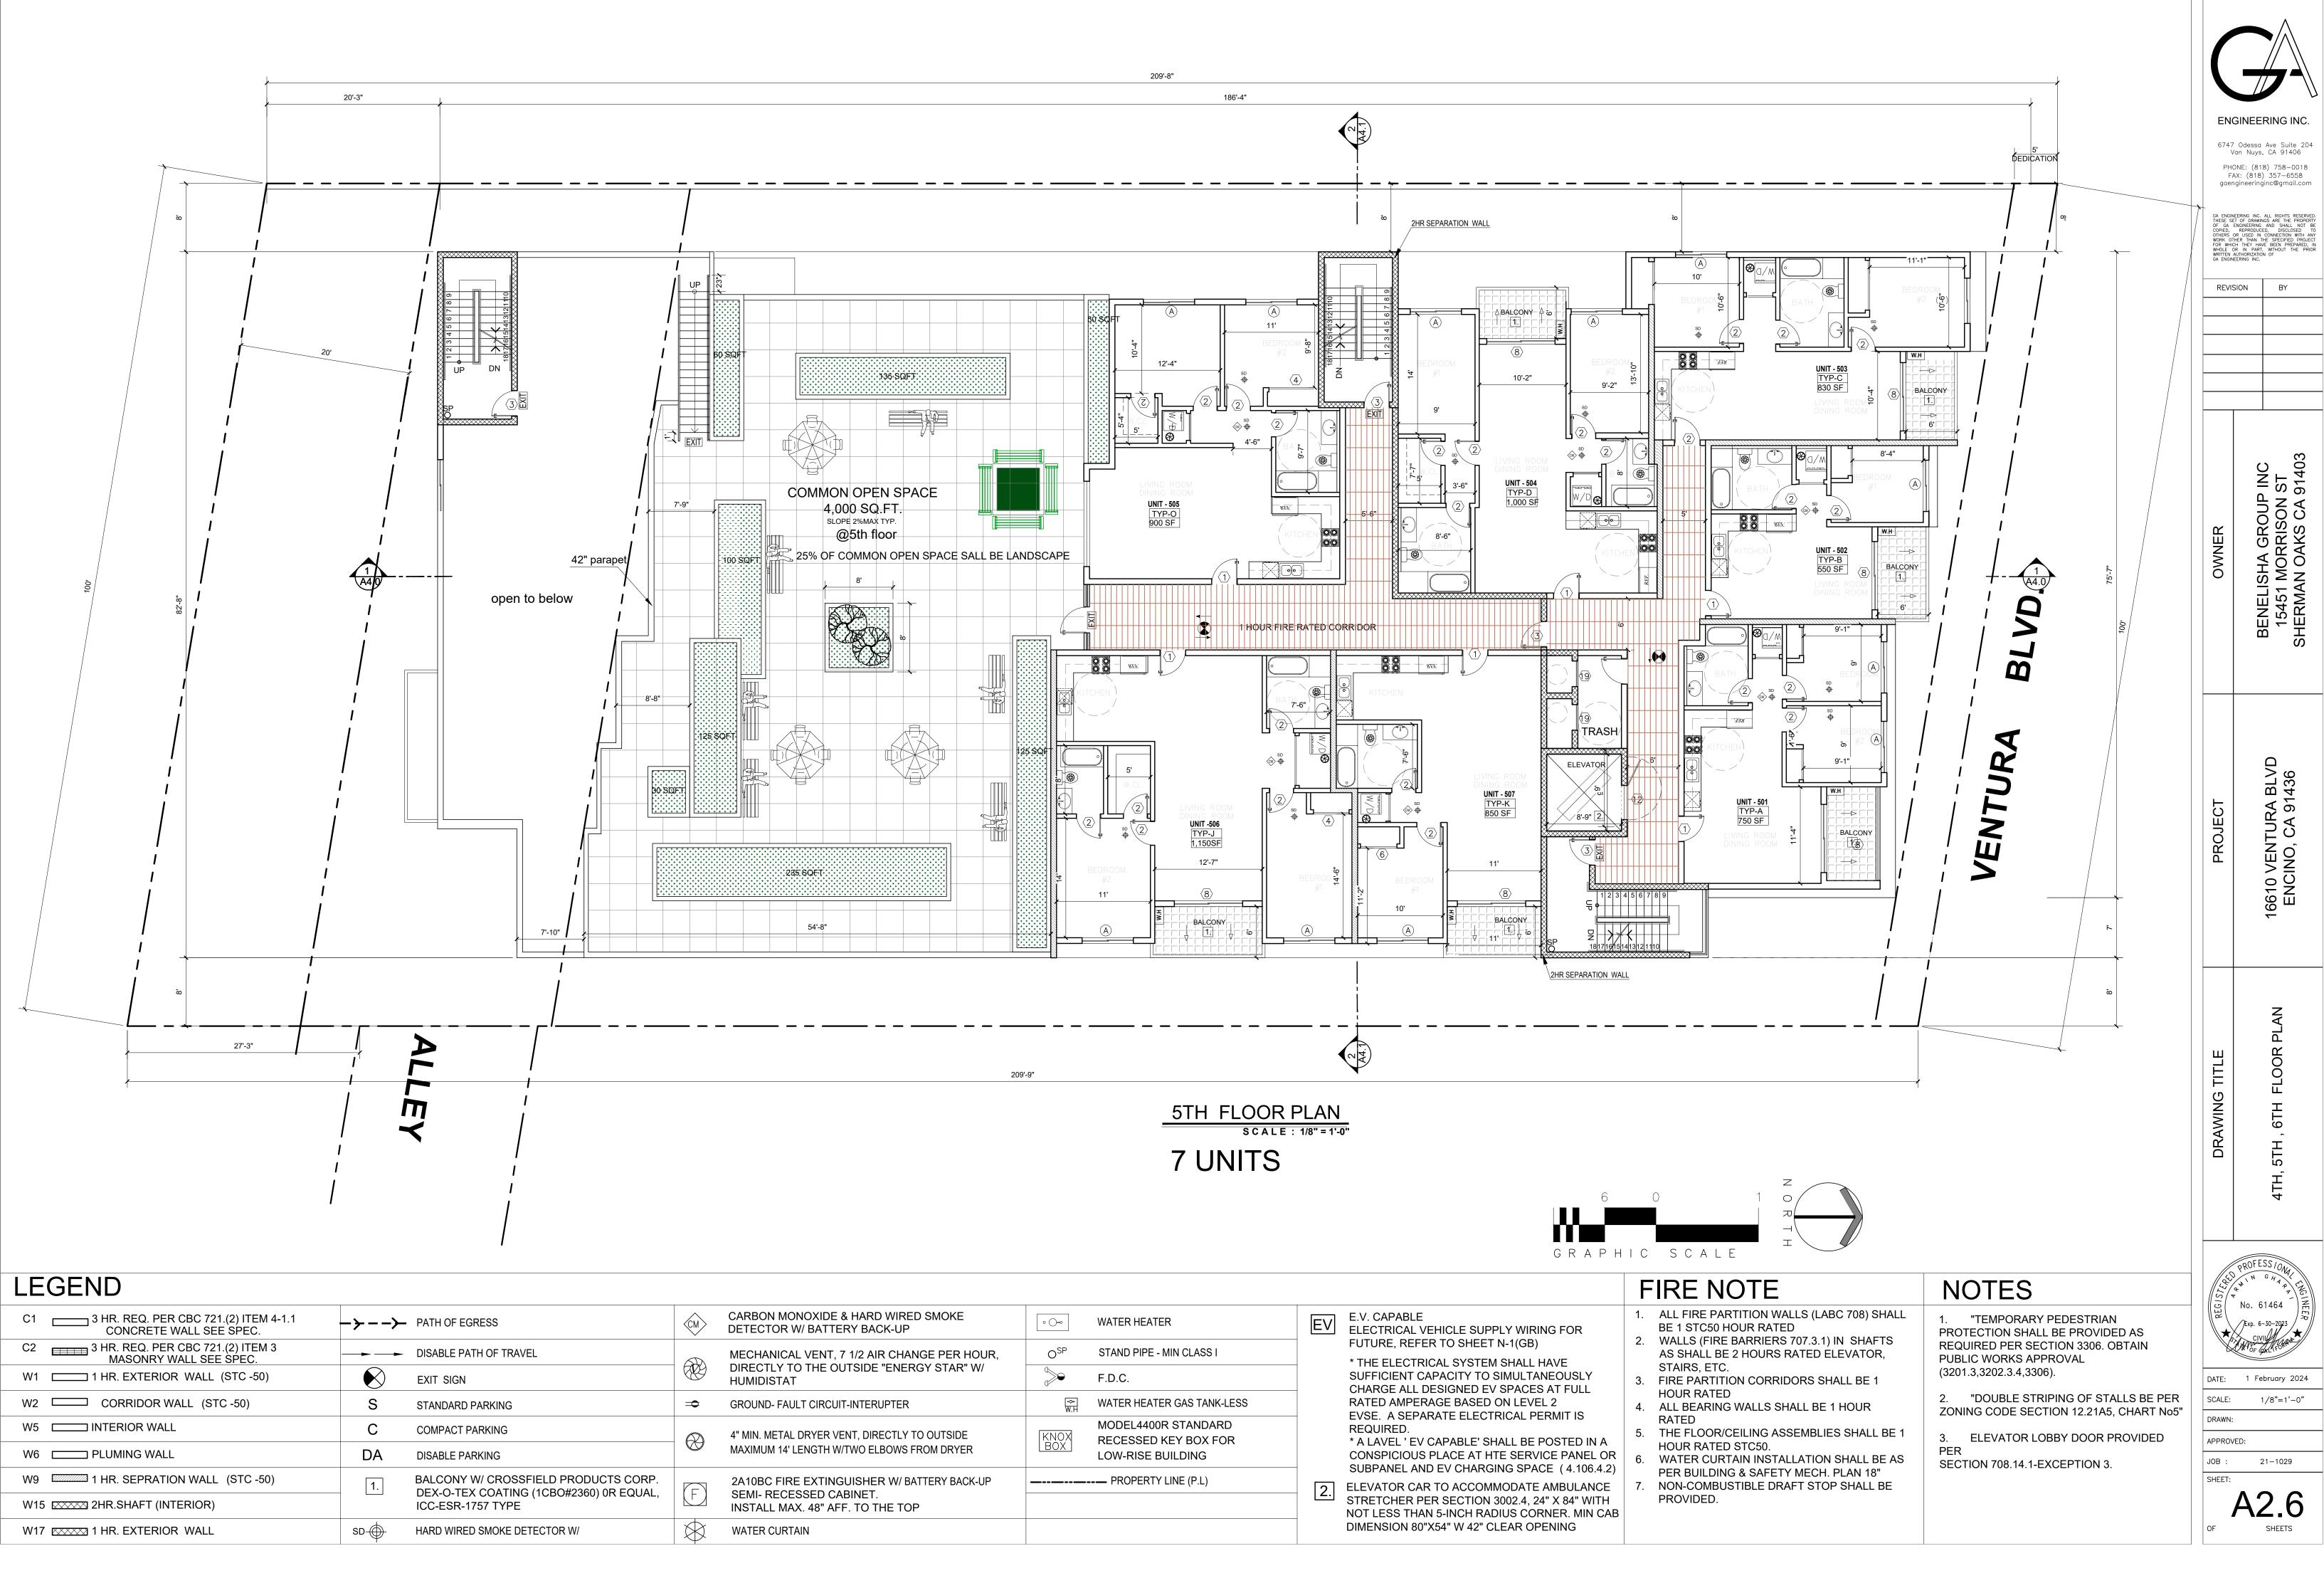

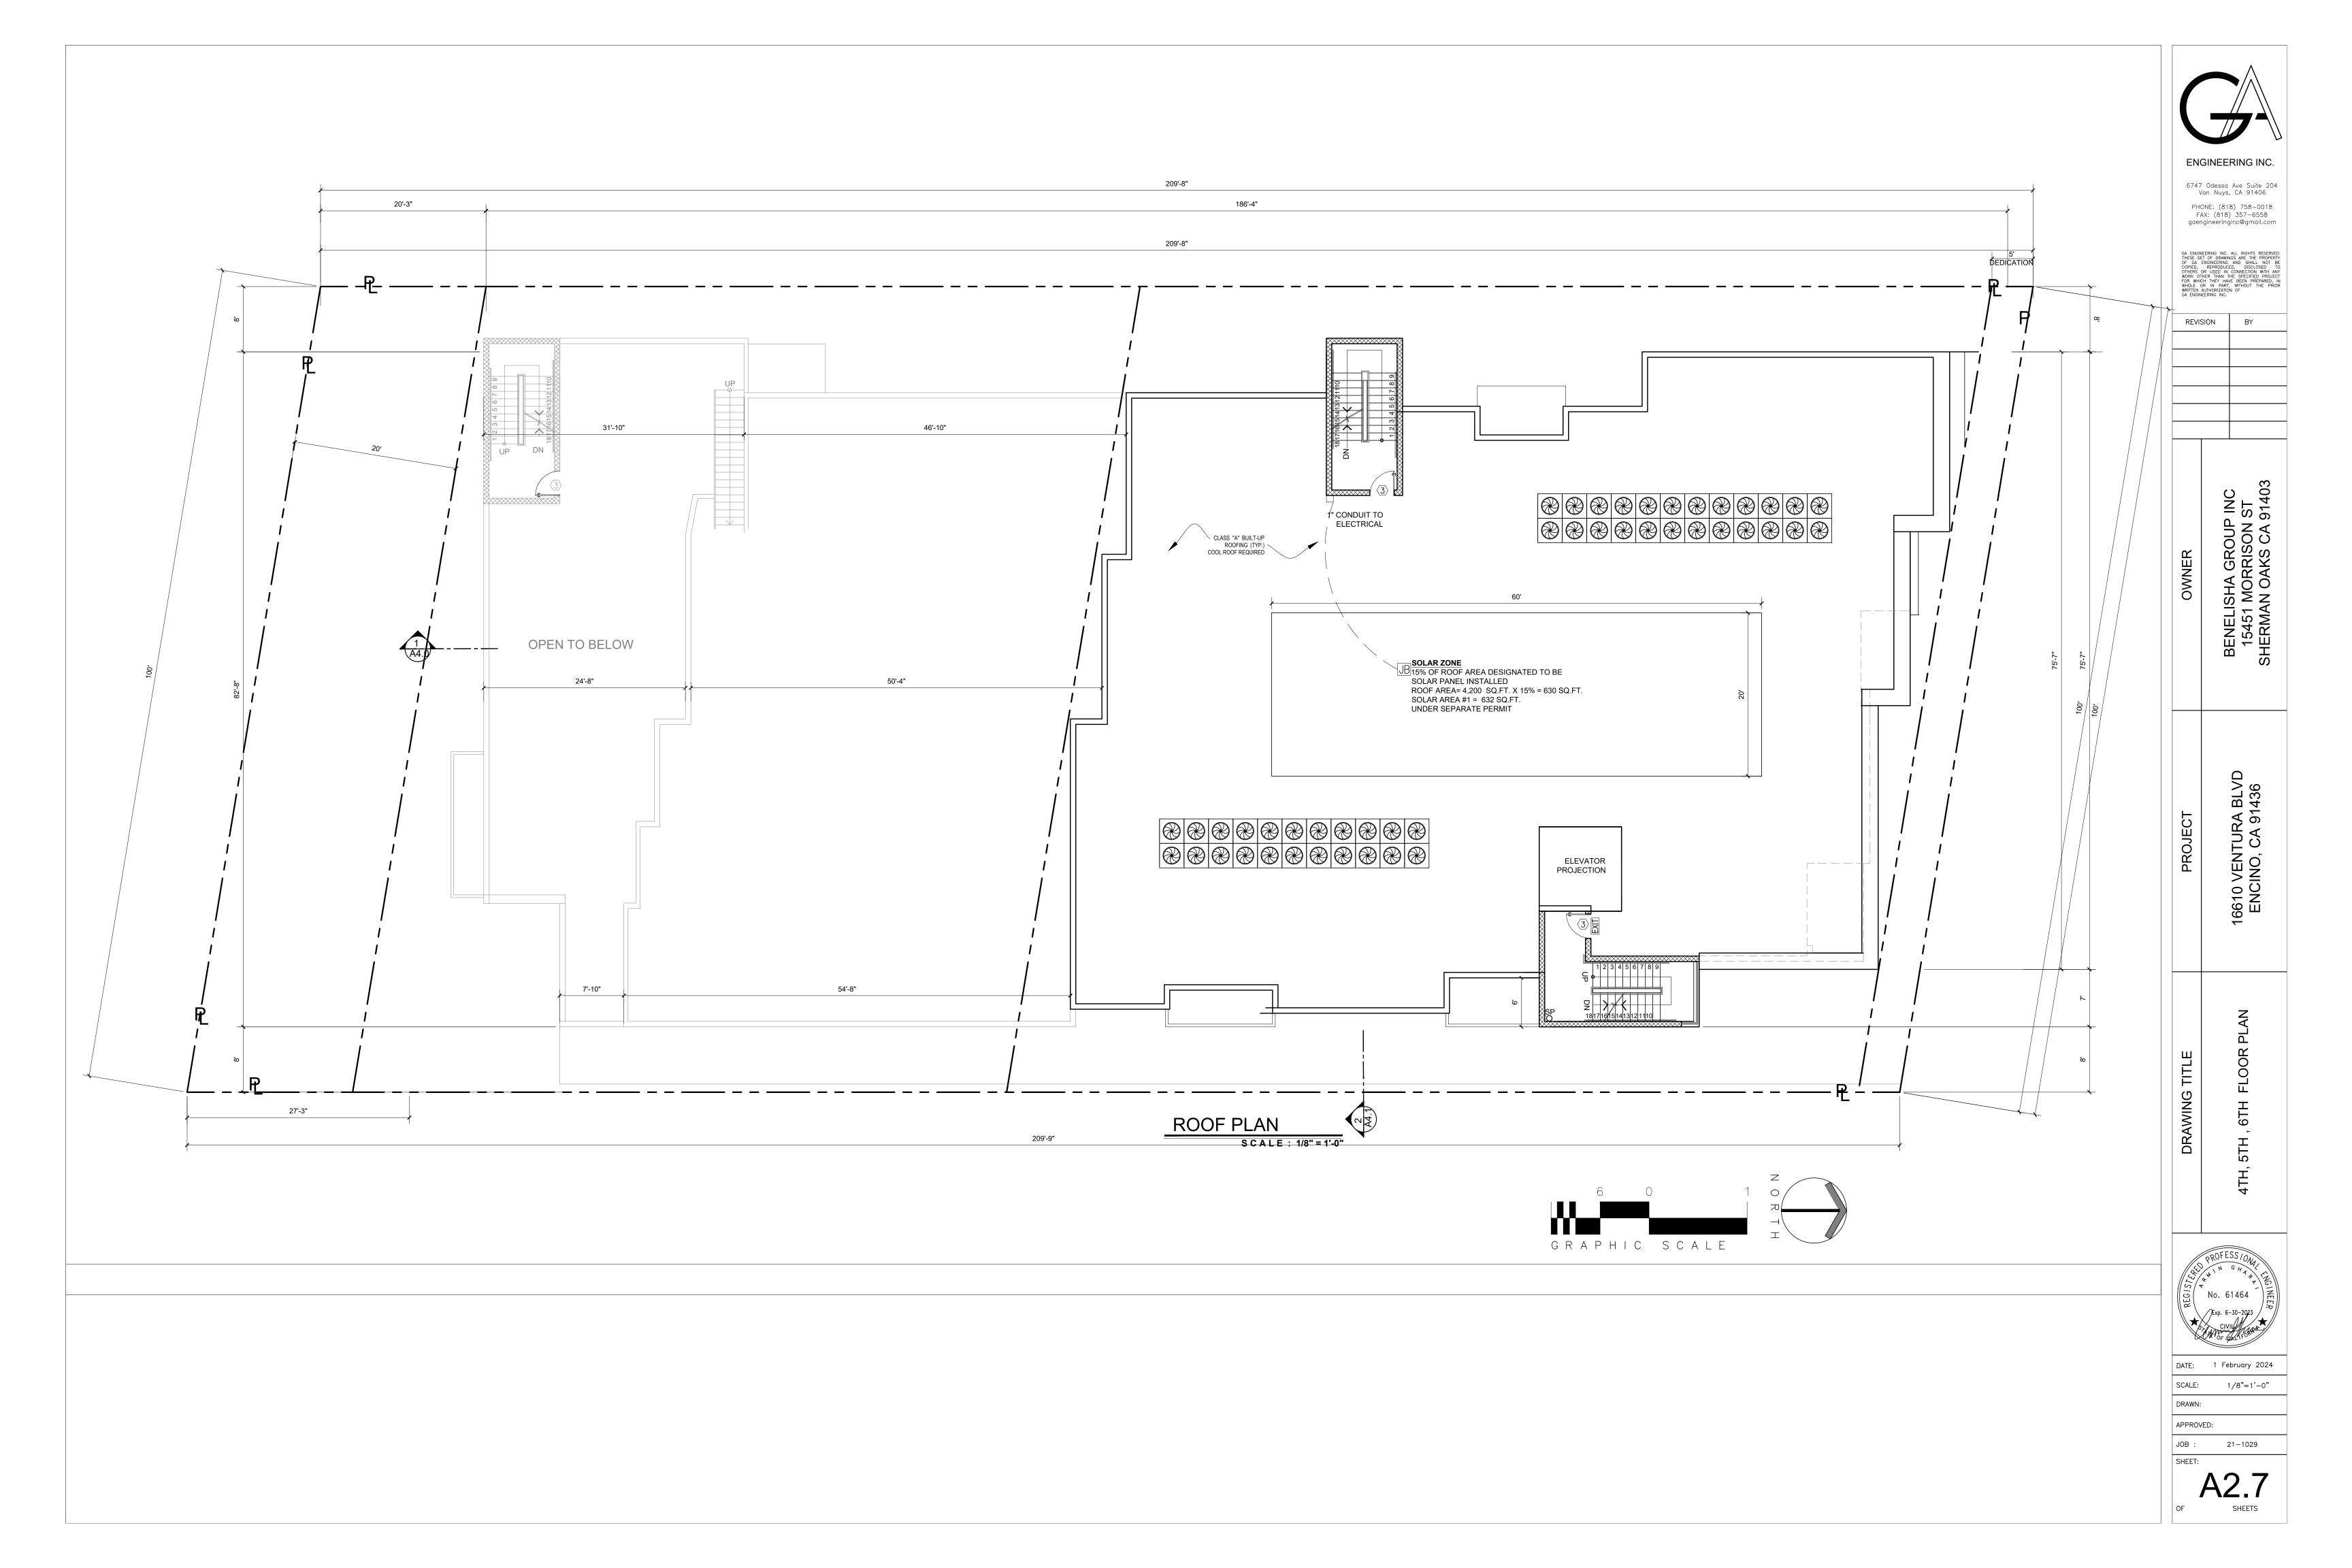



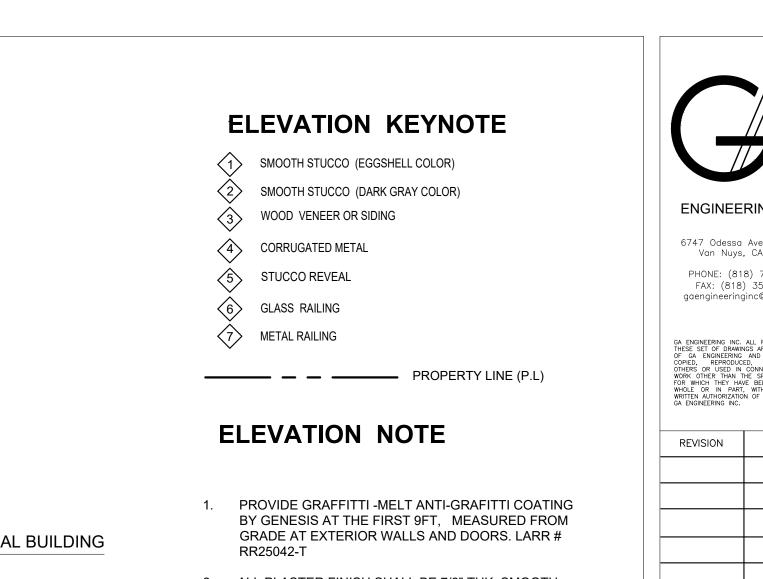





NORTH ELEVATION

SOUTH ELEVATION

DATE:

SCALE:

DRAWN:

SHEET:

OF

APPROVED:

JOB : 21-1029

A3.2

SHEETS

1 February 2024

1/8"=1'-0"





ELEVATION KEYNOTE

- SMOOTH STUCCO (EGGSHELL COLOR)
- SMOOTH STUCCO (DARK GRAY COLOR)
- 3 WOOD VENEER OR SIDING
- CORRUGATED METAL
- 5 STUCCO REVEAL 6 GLASS RAILING
- METAL RAILING



ENGINEERING INC.

6747 Odessa Ave Suite 204 Van Nuys, CA 91406 PHONE: (818) 758-0018 FAX: (818) 357-6558 gaengineeringinc@gmail.com

REVISION ΒY BENELISHA GROUP INC 15451 MORRISON ST SHERMAN OAKS CA 91403 OWNER 16610 VENTURA BLVD ENCINO, CA 91436 PROJECT **EVATIONS** DRAWING TITLE Ш RED Ð. COL No. 61464 DATE: 1 February 2024 1/8"=1'-0" SCALE: DRAWN: APPROVED: JOB : 21-1029 SHEET: A3.3

SHEETS

OF

EAST ELEVATION

WEST ELEVATION





NORTH ELEVATION / VIEW FROM VENTURA

